## STADIUM, PRESS BOX ENCLOSURE for

# CARL KUSS FIELD **BASEBALL FACILITY**


at City of West Bend Regner 800 North Main Street West Bend, Wisconsir Washington County



X X.	<u> DESIGN PARAMETERS — STADIUM</u>	<u> DESIGN PARAMETERS – PRESS BOX</u>	INDEX SHEET	OF DRAWINGS DESCRIPTION	REV
X &	<u>(AS PER 2015 IBC CODE-ICC 300-12)</u>	(AS PER 2015 IBC CODE-ICC 300-12)		GENERAL	
	CLASSIFICATION (SECTION 302)	CLASSIFICATION (SECTION 302)	<ul><li>★ 1</li><li>★ 2</li></ul>	COVER SHEET CODE SUMMARY	0
	ASSEMBLY - GROUP A	BUSINESS - GROUP B	★ 3	PURCHASED PARTS	0
	OCCUPANCY (SECTION 303.6)	OCCUPANCY (SECTION 303.1.2)	★ 4	PROJECT SITE PLAN	0
	A-5	B		STADIUM	0
			★ 5	PLAN VIEW	0
	LIVE LOADS	FLOOR LOAD = 60 PSF	★ 6	FOUNDATION PLAN	
	VERTICAL LOADS = $100 \text{ PSF}$	LIVE LOAD = 50 PSF	★ / ★ 8A	FOUNDATION SECTION FOUNDATION DETAILS	0
	SEATS & FOOTBOARDS = $120 \text{ PLF}$	DEAD LOAD = 10 PSF	★ 8B	FOUNDATION DETAILS	
	SEATING PLATFORMS = 100 PSF AISLES = 100 PSF		★ 9	STRUCTURAL PLAN	0
		ROOF LOAD = 20 PSF	<b>★</b> 10	STRUCTURAL DETAILS	0
	SWAY LOADS	DEAD LOAD = 10 PSF	★ 11	STRUCTURAL DETAILS	0
	PARALLEL TO SEATING = $24$ PLF	WIND LOADS = 19 PSF	★ 12	STRUCTURAL DETAILS	0
	NORMAL TO SEATING = 10 PLF	(BASED ON 120 MPH AND A STRUCTURE	<ul><li>★ 13</li><li>★ 14</li></ul>	ENCLOSURE PLAN SECTION A – SEATING – HOME PLATE	0
	SNOW LOADS = 25 PSF	HEIGHT OF 26ft OR LESS)	<b>★</b> 14	SECTION B - SEATING - FIRST BASE	0
			★ 16	SECTION C - AISLE @ PRESS BOX	0
	WIND LOADS = 19 PSF	GUARDRAILS = 50 PLF OR 200 LB.	★ 17	SECTION D – AISLE – THIRD BASE	0
	(BASED ON 120 MPH AND A STRUCTURE	(CONCENTRATED LOAD) MATERIALS	<b>★</b> 18	VIEW E – END ELEVATION (NORTH)	0
Park	HEIGHT OF 26ft OR LESS)	STEEL "W" MEMBERS:	★ 19	VIEW E – ENCLOSURE FRAMING	0
Γαιλ	GUARDRAILS = 50 PLF OR 200 LB.	A992, Fy = 50 KSI	★ 20 ★ 21	VIEW F - END ELEVATION (EAST)	0
	GUARDRAILS = 50 PLF OR 200 LB. (CONCENTRATED LOAD)	STEEL REINFORCEMENT ANGLES,	<ul><li>★ 21</li><li>★ 22</li></ul>	VIEW F – ENCLOSURE FRAMING VIEW G – FRONT ELEVATION (NORTHEAST)	0
L	MATERIALS	CLIP ANGLES, & PLATES:	★ 23	VIEW B - BACK ELEVATION (NOITHLAST)	0
	STEEL "W" MEMBERS:	ASTM A-36, Fy = 36 KSI	★ 24	VIEW H – BACK FRAMING	0
	A992, Fy = 50 KSI	WOOD FRAMING:	★ 25	VIEW H – BACK ENCLOSURE DETAILS	0
	STEEL REINFORCEMENT ANGLES,	WALL STUDS & CEILING JOISTS = SPF	<b>★</b> 26	ADA RAMP PLAN VIEW	0
า	CLIP ANGLES, & PLATES: ASTM A-36, Fy = 36 KSI	f'b = 1250 PSI (SELECT STRUCTURAL)	★ 27	ADA RAMP SECTIONS	0
	ASTM $A=30$ , $Fy = 30$ KS	FLOOR JOISTS = SOUTHERN YELLOW PINE MSR	<ul><li>★ 28</li><li>★ 29</li></ul>	ADA RAMP DETAILS ACCESS STAIR (NORTH)	0
	ALUM:	f'b = 1950 PSI (MACHINE STRESS RATED)	★ 30	ACCESS STAIR (NORTH)	0
	EXTRUSIONS = $6063 - T6$	FASTENERS	★ 31	ADA WHEELCHAIR SEATING	0
	FORMED ALUM PLATE SHAPES = 5052-H32	PRIME CONNECTIONS = $A325 - GALVANIZED$		PRESS BOX	0
	FASTENERS	ALL OTHERS = $A325 \& GRADE 5 - GALVANIZED$	★ 32	PLAN VIEW	0
	PRIME CONNECTIONS = $A325 - GALVANIZED$		★ 33	STRUCTURAL PLAN	0
	ALL OTHERS = A325 & GRADE 5 - GALVANIZED		★ 34	STRUCTURAL DETAILS	0
			<ul><li>★ 35</li><li>★ 36</li></ul>	SECTION TYP ELEVATIONS	0
	DESIGN SOIL BEARING PRESSURE = 3.0 KSF			ES DRAWINGS ISSUED AS PART OF THIS LATEST REVISION	_
	SEISMIC DESIGN CATEGORY = B				
	SITE CLASS = D				
	$S_{s} = 0.076g$				
	$S_1 = 0.042g$				
	$S_{DS} = 0.081g$				
	$S_{D1} = 0.068g$	LAYOUT DESIGN	JATION		
				<u>`</u>	
		REFERENCE:			
	<u> DESIGN PARAMETERS — ENCLOSURE</u>	INSIDE CORNERS OF FROI	NT WALKV	VAY	
	<u>(AS PER 2015 IBC CODE-ICC 300-12)</u>	BEHIND HOME PL	ATE		
		= 17' - 10'' CRITI	CAL		
ლე <mark>ა</mark> Հ	CLASSIFICATION (SECTION 311)				
-ም 1	STORAGE - GROUP S				
	$\Delta C = 0$	BACK POINT OF HOME			
	OCCUPANCY (SECTION 311.3)		IG A4		
	S-2	CENTER OF FOOTIN			
	S-2	$\begin{array}{rcl} & \text{CENTER OF FOOTIN} \\ & = 51'-2'' & \text{CRITIC} \end{array}$			
	S-2 WIND LOADS = 19 PSF				
	S-2 WIND LOADS = 19 PSF (BASED ON 120 MPH AND A STRUCTURE				
	S-2 WIND LOADS = 19 PSF	= 51'-2" CRITIC	CAL		
	S-2 WIND LOADS = 19 PSF (BASED ON 120 MPH AND A STRUCTURE		CAL	<u><u>N</u></u>	
	S-2 WIND LOADS = 19 PSF (BASED ON 120 MPH AND A STRUCTURE HEIGHT OF 26ft OR LESS) MATERIALS WALL FRAMING	= 51'-2" CRITIC	cal GNATIC	<u><u>DN</u></u>	
	S-2 WIND LOADS = 19 PSF (BASED ON 120 MPH AND A STRUCTURE HEIGHT OF 26ft OR LESS) MATERIALS WALL FRAMING Fy = 55 KSI	= 51'-2" CRITIC <u>ELEVATION DESIC</u> BENCHMARK 7	DAL GNATIC #1		
	S-2 WIND LOADS = 19 PSF (BASED ON 120 MPH AND A STRUCTURE HEIGHT OF 26ft OR LESS) MATERIALS WALL FRAMING Fy = 55 KSI SIDING	= 51'-2" CRITIC <u>ELEVATION DESIC</u> BENCHMARK F EXISTING HYDRANT	CAL GNATIC #1 RIM BOL		
	S-2 WIND LOADS = 19 PSF (BASED ON 120 MPH AND A STRUCTURE HEIGHT OF 26ft OR LESS) MATERIALS WALL FRAMING Fy = 55 KSI SIDING Fy = 52.7 KSI	= 51'-2" CRITIC <u>ELEVATION DESIC</u> BENCHMARK 7	CAL GNATIC #1 RIM BOL		
	S-2 WIND LOADS = 19 PSF (BASED ON 120 MPH AND A STRUCTURE HEIGHT OF 26ft OR LESS) MATERIALS WALL FRAMING Fy = 55 KSI SIDING	= 51'-2" CRITIC <u>ELEVATION DESIC</u> <u>BENCHMARK</u> <u>FXISTING HYDRANT</u> <u>QUAM=907.96</u>	CAL GNATIC #1 RIM BOL	 T	
WEST BEND, WISCONSIN	S-2 WIND LOADS = 19 PSF (BASED ON 120 MPH AND A STRUCTURE HEIGHT OF 26ft OR LESS) MATERIALS WALL FRAMING Fy = 55 KSI SIDING Fy = 52.7 KSI FASTENERS	= 51'-2" CRITIC <u>ELEVATION DESIC</u> BENCHMARK F EXISTING HYDRANT	CAL GNATIC #1 RIM BOL		INEER ST

REV	DATE	DESCRIPTION	REV BY:	
0	11-17-20	ISSUED FOR STATE PLAN REVIEW	ALR	

	PROJECT: CITY OF WEST BEND REGNER PARK
	CARL KUSS FIELD BASEBALL FACILITY
5662 Glendale Ave. Green Bay, WI 54313	CLIENT: WEST BEND BASEBALL ASSOCIATION
(920) 865-7307 Fax (920) 865-7777	CIVIL ENGINEER: QUAM ENGINEERING, LLC
jwoffice@jwindustriesinc.com	SITE CONTRACTOR: H&H CIVIL CONSTRUCTION, LLC
"We provide everything except the spectat	<b>R5.</b> " JOB#: 20311 DATE: 11-17-20 DRAWN BY: ALR SHEET 1

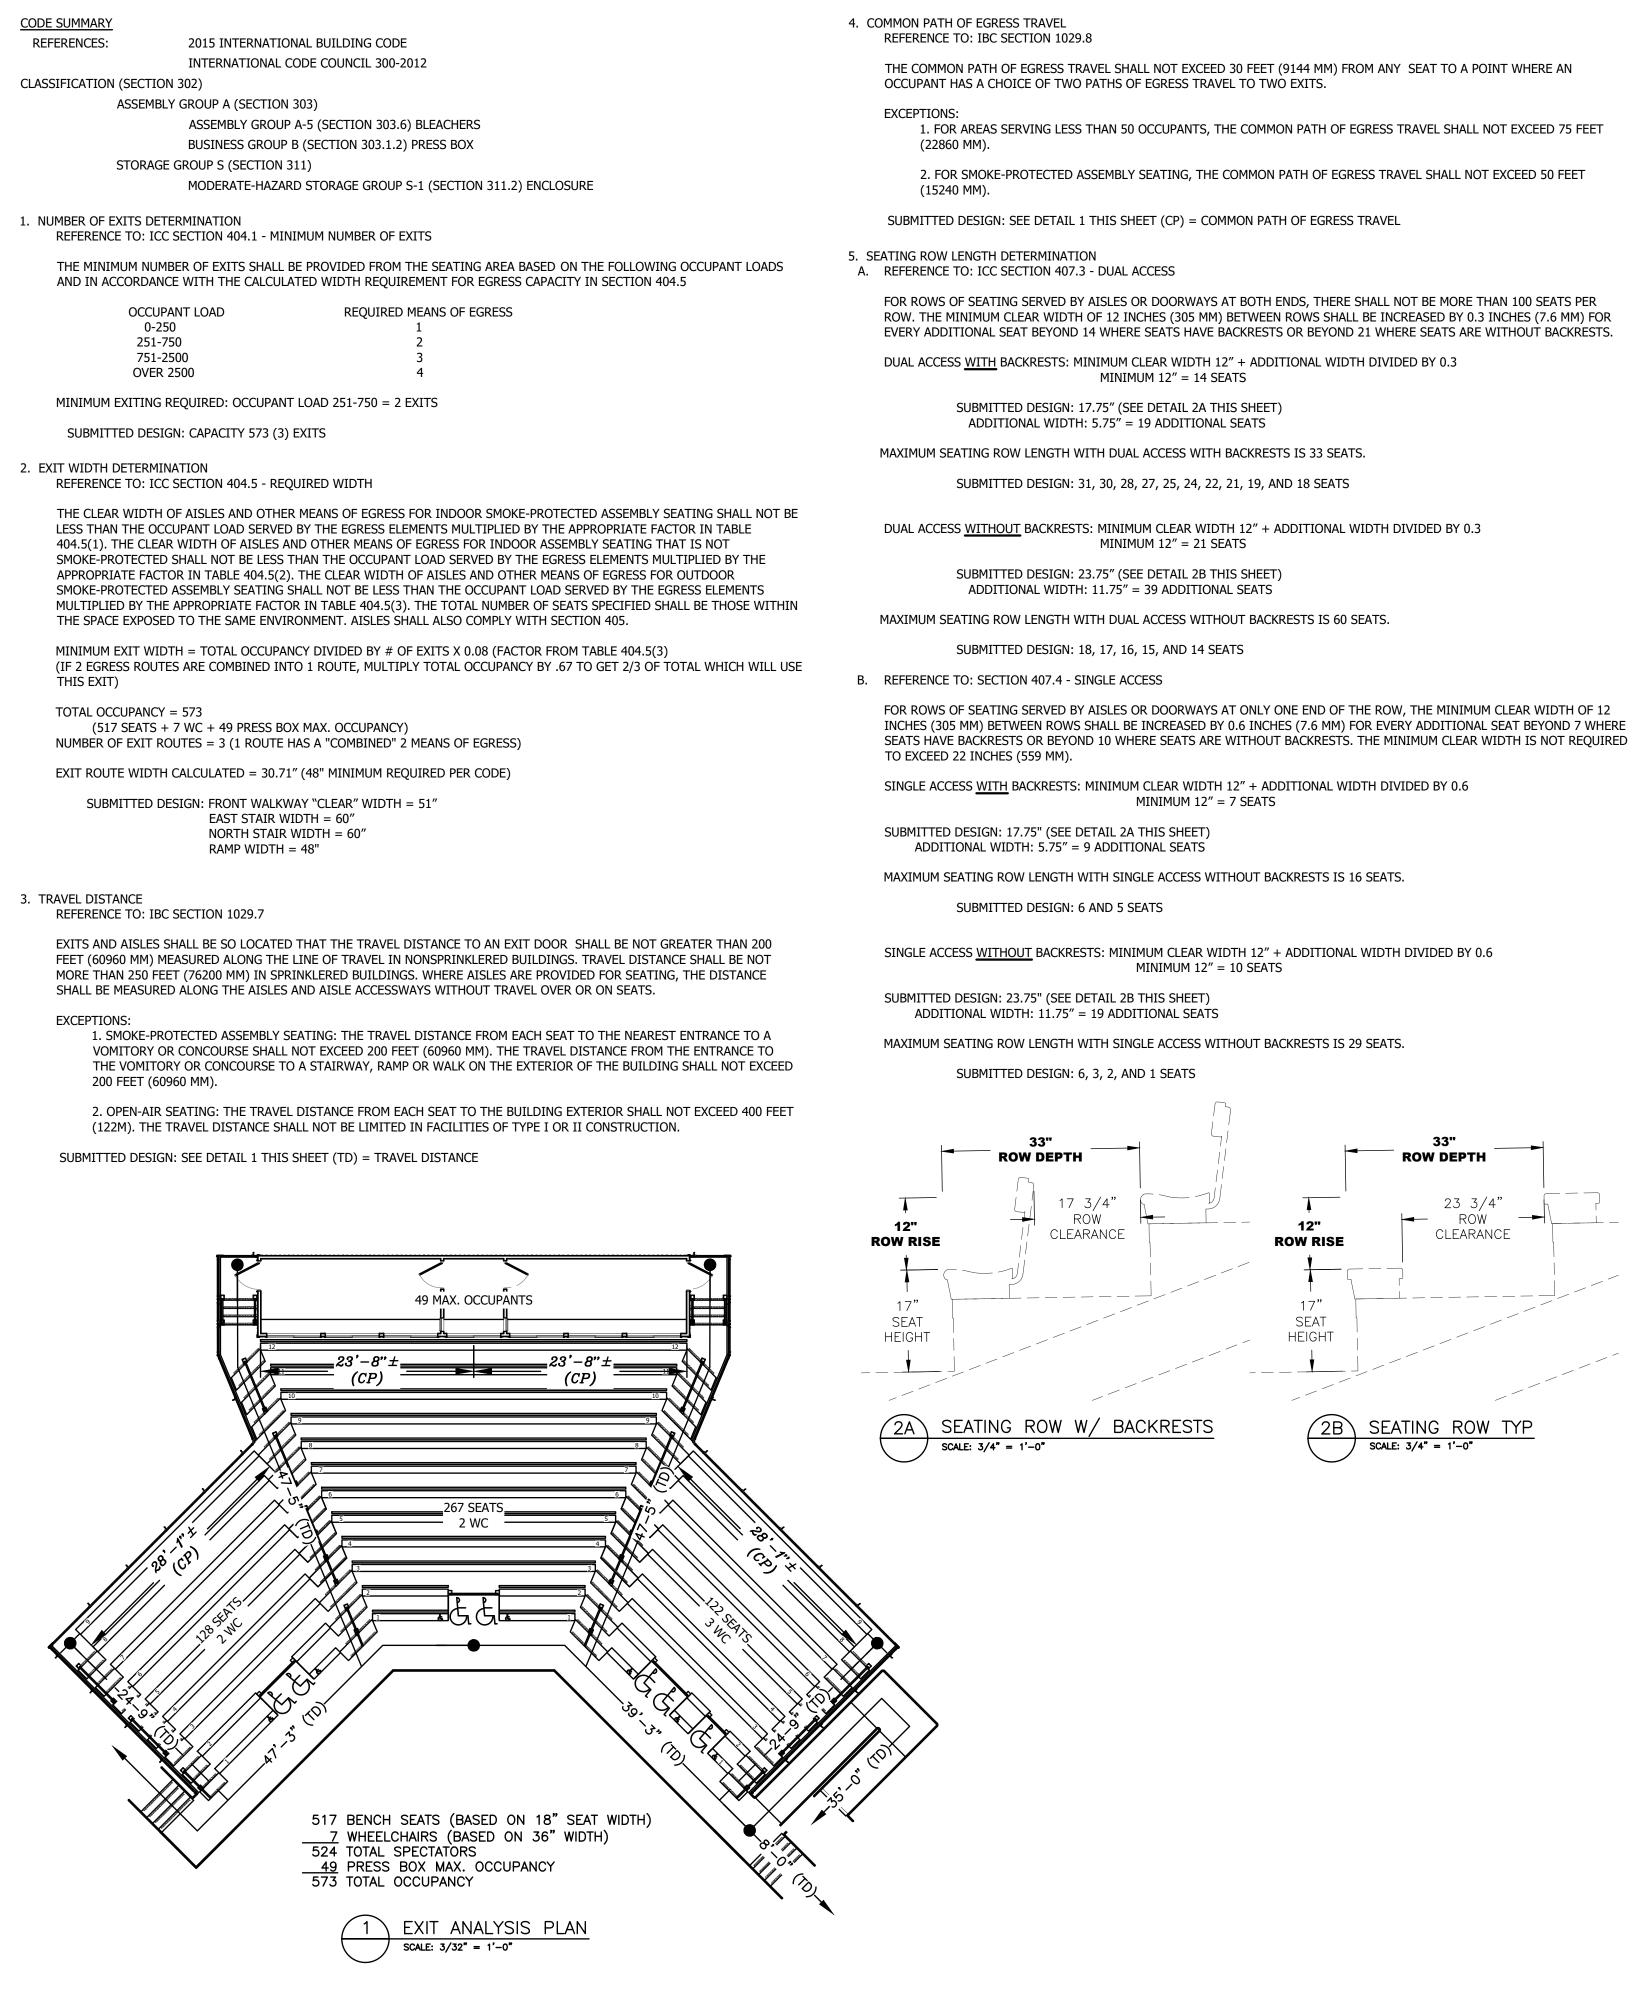

6. ACCESSIBLE SEATING CALCULATION REFERENCE TO: IBC SECTION 1108.2.2.1 GENERAL SEATING

WHEELCHAIR SPACES SHALL BE PROVIDED IN ACCORDANCE WITH TABLE 1108.2.2.1.

WHEELCHAIR SEATING REQUIRED FOR CAPACITY 501 TO 5000 = 6, PLUS 1 FOR EACH 150 A FRACTION 501 THRU 5000.

SUBMITTED DESIGN: SPECTATOR CAPACITY 517 (7) WHEELCHAIRS

7. ACCESSIBLE ROUTE - PRESS BOX REFERENCE TO: IBC SECTION 1104.3.2 PRESS BOXES

PRESS BOXES IN A BUILDING, ROOM, OR SPACE USED FOR ASSEMBLY PURPOSES SHALL BE ON AN ACCESS EXCEPTIONS:

1. AN ACCESSIBLE ROUTE SHALL NOT BE REQUIRED TO PRESS BOXES IN BLEACHERS THAT ENTRY FROM THE BLEACHERS, PROVIDED THAT THE AGGREGATE AREA OF ALL PRESS BOXES FIELD IS NOT MORE THAN 500 SQUARE FEET (46 M<sup>2</sup>). \*SINGLE POINT OF ENTRY AT NORTH DOOR (SEE BELOW)

2. AN ACCESSIBLE ROUTE SHALL NOT BE REQUIRED TO FREE-STANDING PRESS BOXES THAT (3660 MM) ABOVE GRADE PROVIDED THAT THE AGGREGATE AREA OF ALL PRESS BOXES FOR NOT MORE THAN 500 SQUARE FEET (46 M<sup>2</sup>).

THE PRESS BOX FOR THIS PROJECT IS NOT REQUIRED TO HAVE AN ACCESSIBLE ROUTE PER EXCEPTION 12 SUBMITTED DESIGN: 395 TOTAL PRESS BOX SQUARE FEET

EXIT ONLY LOCK PRESS BOX 395 SQ FT 3 PRESS BOX SYSTEM SIZE CALCULATION

SCALE: 1/8'' = 1'-0''

8. HEATING AND VENTILATION OF PRESS BOX REFERENCE TO: SPS 364.0309

> THE PRESS BOX SYSTEM DOES NOT HAVE A SEPARATE HEATING SYSTEM BECAUSE THE MINIMUM TEMPERATURE REQUIRED CAN BE ESTABLISHED AS NO MINIMUM REQUIRED (NMR) DUE TO THE LIMITED USE AND THE FACT THAT THE USE AND TIME OCCUPIED IS SIMILAR OR LESS THAN THE OTHER OCCUPANCIES THAT HAVE "NMR" LISTING IN SPS TABLE 364.0309.

SUBMITTED DESIGN: "NOT HEATED"

THE PRESS BOX SYSTEM DOES NOT HAVE A SEPARATE VENTILATION SYSTEM BUT RATHER UTILIZES "NATURAL VENTILATION (PER 402.1) OF AN OCCUPIED SPACE SHALL BE THROUGH WINDOWS, DOORS, LOUVERS OR OTHER OPENINGS TO THE OUTDOORS." PER (402.2) THE VENTILATION AREA REQUIRED - THE MINIMUM OPENABLE AREA TO THE OUTDOORS SHALL BE 4 PERCENT OF THE FLOOR AREA BEING VENTILATED.

THE AREA OF OPENINGS FOR THIS 395 SQUARE FOOT PRESS BOX BASED ON THE 4% MINIMUM WOULD BE 16 SQUARE FEET. SUBMITTED DESIGN: 210 SQUARE FEET = 53%


(TOTAL OF 7 EXTERIOR WINDOWS AND 2 DOORS)

9. CAPACITY OF PRESS BOX REFERENCE TO: IBC SECTION 1004.1.2 AREAS WITHOUT FIXED SEATING

THE NUMBER OF OCCUPANTS SHALL BE COMPUTED AT THE RATE OF ONE OCCUPANT PER UNIT AREA AS PRESCRIBED IN TABLE 1004.1.2. FOR AREAS WITHOUT FIXED SEATING, THE OCCUPANT LOAD SHALL BE NOT LESS THAN THAT NUMBER DETERMINED BY DIVIDING THE FLOOR AREA UNDER CONSIDERATION BY THE OCCUPANT LOAD FACTOR ASSIGNED TO THE FUNCTION OF THE SPACE AS SET FORTH IN TABLE 1004.1.2.

PER TABLE 1004.1.2, THE PRESS BOX IS CONSIDERED ASSEMBLY WITHOUT FIXED SEATS, CONCENTRATED (CHAIRS ONLY-NOT FIXED) = 7 NET.

SUBMITTED DESIGN: 56 MAXIMUM OCCUPANTS BY CALCULATION BUT BASED ON IBC 303.1.2, THE MAXIMUM CAPACITY FOR THE PRESS BOX IS 49

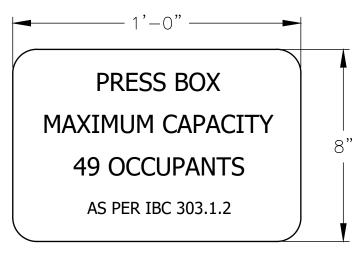




REV	DATE	DESCRIPTION	REV BY:	
0	11-17-20	ISSUED FOR STATE PLAN REVIEW	ALR	
				<b>L</b>

	10. ENCLOSURE AND STORAGE BENEATH OUTDOOR ASSEMBLY SEATING REFERENCE TO: IBC 302.1 & 903.3.1.1.1
N THERE OF, BETWEEN	THIS STRUCTURE SERVES AS MULTI USE FACILITY; SEATING FOR OBSERVERS OF FIELD ACTIVITIES (GROUP A-5), AND STORAGE SPACE FOR ITEMS THAT WILL SUPPORT THE ACTIVITIES (GROUP S-1). THE STRUCTURE WAS DESIGNED TO MEET THE MOST RESTRICTIVE REQUIREMENTS FOR EACH OF THESE OCCUPANCIES.
	THE CODE LANGUAGE OF IBC 302.1 THAT CLASSIFIES ACTIVITIES INTO OCCUPANCY CATEGORIES IS: "A ROOM OR SPACE THAT IS INTENDED TO BE OCCUPIED AT DIFFERENT TIMES FOR DIFFERENT PURPOSES SHALL COMPLY WITH ALL OF THE REQUIREMENTS THAT ARE APPLICABLE TO EACH OF THE PURPOSES FOR WHICH THE ROOM OR SPACE WILL BE OCCUPIED"
ESSIBLE ROUTE .	THE STRUCTURE'S DESIGN MEETS THE SPRINKLERING REQUIREMENTS FOR GROUP A-5 OCCUPANCIES BY CREATING A STORAGE AREA OF LESS THAN 1,000 SQ. FT. AND AN AREA, OVER 1,000 SQ. FT., FOR NONCOMBUSTIBLE STORAGE MEETING THAT MEETS IBC 903.3.1.1.1 CONDITION 4 WHICH ALLOWS SPRINKLERS TO BE OMITTED IN SPACES THAT HAVE NONCOMBUSTIBLE CONSTRUCTION WITH NONCOMBUSTIBLE CONTENT WHEN AN APPROVED FIRE DETECTION SYSTEM IS INSTALLED.
t have a single point of Es for each playing	SUBMITTED DESIGN: AREA # SQUARE FEET POLICE DEPT 287 PARKS #1 602 PARKS #2 602 TRAINING 287
AT ARE MORE THAN 12 FEET	
or each playing field is	11. TOILET FACILITIES REFERENCE TO: IBC SECTION 2902.3.2
1104.3.2.1.	"TOILET FACILITIES SHALL BE PROVIDED WITHIN 500 FEET TO ACCOMMODATE BLEACHER OCCUPANT LOAD".
	AN EXISTING RESTROOM FACILITY IS LOCATED DIRECTLY BEHIND THE STADIUM TO MEET THESE REQUIREMENTS.
	CURNITED DECION 22 FEFT

SUBMITTED DESIGN: 32 FEET

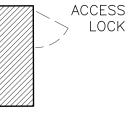

JW INDUSTRIES INC. CITY OF WEST BEND REGNER PARK CARL KUSS FIELD BASEBALL FACILITY **5662** Glendale Ave. WEST BEND BASEBALL ASSOCIATION GREEN BAY, WI 54313 CIMIL ENGINEER: QUAM ENGINEERING, LLC (920) 865-7307 Fax (920) 865-7777 SITE CONTRACTOR H&H CIVIL CONSTRUCTION, LLC jwoffice@jwindustriesinc.com "We provide everything except the spectators." [JOB#: 20311 DATE: 11-17-20 DRAWN BY: ALR SHEET NUMBER:


PROFESSIONAL ENGINEER STAMP


### <u>HOME SIDE STADIUM</u> PURCHASED PARTS LIST


	PURCHASED	
ITEM	<u>MANUFACTURER</u>	DESCRIPTION
FRAMING COMPONENT FINISH	AZZ GALVANIZING	HOT DIPPED GALVANIZED ASTM A123
DECK PLATE	HEIDTMAN STEEL PRODUCTS	14 GA MEDIUM PATTERN DECK PLATE 4 WAY STEEL A–527 MIN, HOT–ROLLED, ASTM GRADE A786, FINISH: GALVANIZED COATED G90 SPANGLE TYPE: "MINIMUM", LIGHT OIL, CHEM TREATED
NON-SKID TAPE	3М	2" WIDE SAFETY WALK GRIP TAPE-CONFORMABLE COLOR: BLACK
SEAT PLANK (CENTER SECTION)	LINETEC	CONTOURED 2 x 12 x 0.078 WALL THICKNESS FINISH: CLEAR ANODIZED $#204-R1$ 1 $3/4$ "
SEAT PLANK (WING SECTIONS)	LINETEC	2 x 10 x 0.085 WALL THICKNESS FINISH: CLEAR ANODIZED $#204-R1$ 9 1/4" 1 3/4"
SEAT BRACKET FINISH	N/A	ALUMINUM FINISH: MILL
BACKREST PLANK (CENTER SECTION)	GORDON	2 x 6 x 0.085 WALL THICKNESS 5 3/4"
	TBD	FINISH: POWDER-COAT PAINTED SUPER-DURABLE POLYESTER COLOR: GRAY
BACKREST BRACKET FINISH	AZZ GALVANIZING	HOT–DIPPED GALVANIZED ASTM A123
MID-AISLE RAILING FINISH	GREEN BAY ANODIZING	CLEAR ANODIZED #204-R1
WHEELCHAIR SLOT RAILING FINISH	GREEN BAY ANODIZING	CLEAR ANODIZED #204-R1
WHEELCHAIR RAMP FRAMING FINISH	AZZ GALVANIZING	HOT-DIPPED GALVANIZED ASTM A123
WHEELCHAIR RAMP RAILING FINISH	AZZ GALVANIZING	HOT-DIPPED GALVANIZED ASTM A123
STAIR FRAMING FINISH	AZZ GALVANIZING	HOT–DIPPED GALVANIZED ASTM A123
STAIR RAILING FINISH	AZZ GALVANIZING	HOT-DIPPED GALVANIZED ASTM A123
GUARDRAIL POST FINISH	AZZ GALVANIZING	HOT-DIPPED GALVANIZED ASTM A123
GUARDRAIL CHAIN LINK FABRIC	STEPHENS PIPE & STEEL CO.	GALVANIZED
GUARDRAIL PIPE	STEPHENS PIPE & STEEL CO.	GALVANIZED
GUARDRAIL WIRE TIES	STEPHENS PIPE & STEEL CO.	ALUMINUM
TENSION BARS, PANEL CLAMPS, RAIL ENDS	STEPHENS PIPE & STEEL CO.	GALVANIZED
ACCENT PANELS (BACK & SIDES)	PETERSEN ALUMINUM CO.	24 GA. STEEL BRAKE METAL COLOR: SLATE GRAY


	DDECC	ROY			
	<u>PRESS</u> <u>PURCHASED</u>				<u>ENCLOSURE</u> PARTS LIST
ITEM	<u>MANUFACTURER</u>	DESCRIPTION	ITEM	<u>MANUFACTURER</u>	DESCRIPTION
ROOF	PETERSEN ALUMINUM CO.	PAC-CLAD M-36 (VERTICAL) 24 GA $\times$ 38" PANEL (COVERS 36") COLOR: SLATE GRAY 36" $6$ " $6$ " $3/4$ "	WALL FRAMING	McELROY METAL, Inc.	HORIZONTALS: 8" x 2 1/2" x 16 GA "CEE" GIRT VERTICALS: 8" x 3 1/2" x 16 GA "CEE" GIRT G90 GALVANIZED FINISH
ROOF FASCIA ROOF	PETERSEN ALUMINUM CO. GAP GREAT	24 GA. STEEL COLOR: SLATE GRAY #30 ASPHALT ROOFING FELT	WALL FRAMING (AT UNDERSIDE CEILING)	McELROY METAL, Inc.	SUB-GIRT MSG 3 18 GAUGE GALVANIZED
UNDERLAYMENT ROOF SHEETING	ASPHALT PRODUCTS LOUISIANA-PACIFIC	7/16" OSB			<b>→</b> 6" <b>→</b>
ROOF SOFFIT	PETERSEN ALUMINUM CO.	PAC-750 SOFFIT SOLID PANEL (NON-VENTED) .032 ALUMINUM COLOR: SLATE GRAY	WALL SIDING	PETERSEN ALUMINUM CO.	PAC-CLAD M-36 (VERTICAL) 24 GA x 38" PANEL (COVERS 36") COLOR: CITYSCAPE (GRAY) -36"
VAPOR BARRIER WALL SIDING	DUPONT PETERSEN ALUMINUM CO.	"TYVEK" HOME WRAP PAC-CLAD M-36 (VERTICAL) 24 GA × 38" PANEL (COVERS 36")	CORNER TRIM	PETERSEN ALUMINUM CO.	24 GA STEEL
		COLOR: CITYSCAPE (GRAY) $36^{"} - 6^{"} - 6^{"} - 6^{"}$	VERTICAL     WALK THRU DOORS	AJ MANUFACTURING Inc.	COLOR: CITYSCAPE (GRAY) 7100 SERIES $3'-0''w \times 6'-8''h$
WALL CORNER TRIM	PETERSEN ALUMINUM CO.	24 GA. STEEL COLOR: CITYSCAPE (GRAY)	(EXTERIOR) (4 REQ'D)		INSULATED STEEL DOOR REVERSIBLE LOCK SIDE THRESHOLD W/DOOR SWEEP DOOR CLOSER PROVIDED
WINDOWS	AJ MANUFACTURING Inc.	FRONT: (7 REQ'D) 72"w x 48"h (ROUGH OPENING) HARMONY SERIES (NEW CONSTRUCTION TYPE) TWIN VENT (DOUBLE) SLIDER W/ LOW E GLASS, DOUBLE LOCKS AND FULL SCREEN COLOR: WHITE	LOCKSETS	SCHLAGE	COLOR: WHITE SATURN 626 MODEL #S51 US26D KA6
SUBFLOOR SHEETING	HUBER ENGINEERED WOODS COMPANY	23/32" T&G OSB "ADVANTECH"	ROLL-UP OVERHEAD	TRAC-RITE DOOR, Inc.	(LEVER/LEVER) WITH STRIKE SECURITY PLATE CENTER: (2 REQ'D) 10'-0"w x 10'-0"h
WALK THRU DOOR (EXTERIOR) (2 REQ'D)	AJ MANUFACTURING Inc.	7100 SERIES 3'-0"w x 6'-8"h INSULATED STEEL DOOR REVERSIBLE LOCK SIDE THRESHOLD W/DOOR SWEEP DOOR CLOSER PROVIDED COLOR: WHITE	DOOR (EXTERIOR)		WINGS: (2 REQ'D) $10'-0"w \times 6'-2"h$ MODEL 944 COLOR: ICED WHITE JAMB BRUSH SEAL (4=10' HIGH) #603780 (PUR237a) (4=6'-2" HIGH) #603780 (PUR237A) HEADER DRAFT STOP
LOCKSETS (EXTERIOR NORTHWEST DOOR)	SCHLAGE	ACCESS LOCK – SATURN 626 MODEL #S51PD–SAT626 (LEVER/LEVER) WITH STRIKE SECURITY PLATE FINISH: SATIN CHROME			(4=10' WIDE) #502520(PUR280) LOCK TYPE: SPACE GUARD LATCH (EXTERNAL)
LOCKSETS (EXTERIOR SOUTHEAST DOOR)	SCHLAGE	EXIT LOCK – SATURN 626 MODEL #AL25D-SAT626 (LEVER HANDLE & OUTSIDE BLANK PLATE) WITH STRIKE SECURITY PLATE FINISH: SATIN CHROME	ROLL-UP DOOR TRIM INTERIOR DIVIDER WALL SIDING	PETERSEN ALUMINUM CO. McELROY METAL, Inc.	24 GA STEEL COLOR: CITYSCAPE (GRAY) MAX-RIB ULTRA PVF 29 GA STEEL COLOR: REGAL WHITE
WALK THRU DOORS & TRIM (INTERIOR) (2 REQ'D: 1 LHR/1 RHR)	MASTERCRAFT	PREHUNG 36"x80" PRIMED SMOOTH, FLUSH, FLAT, SINGLE DOOR, SOLID CORE, BORE WITH EDGE PREP AND MORTISED, 4 9/16" (2X4 CONSTRUCTION) PRIMED WOOD CORE FRAME, SATIN NICKEL HINGES ROUGH OPENING 38"X 82 ½"			
LOCKSETS (INTERIOR DOORS)	SCHLAGE	LOCK – LATITUDE 619 MODEL #F10–LAT619 (LEVER/LEVER) FINISH: SATIN NICKEL			
WINDOWS (INTERIOR) (2 REQ'D)	HARMONY	18"w x 48"h (ROUGH OPENING) HARMONY PICTURE WINDOW CUSTOM NO TRIM COLOR: WHITE			
SUBFLOOR SHEETING	HUBER ENGINEERED WOODS COMPANY	23/32" T&G OSB "ADVANTECH"			
CARPET	SHAW CARPET CO.	WINDSURF COLLECTION COLOR: DRIZZLE #00500 (GRAY)			
INTERIOR WALL PANELS	LOUISIANA-PACIFIC	"SMARTSIDE" 7/16" T&G COMPOSITE PANEL COLOR: ALABASTER #SW7008 (OFF-WHITE)			
INTERIOR CEILING PANELS	LOUISIANA-PACIFIC	"SMARTSIDE" 7/16" T&G COMPOSITE PANEL COLOR: ALABASTER #SW7008 (OFF-WHITE)			PROFESSIONAL ENGINEER
COUNTERTOP	PIONITE	COLOR: GRAVEYARD OF THE ATLANTIC #AG611SD (GRAY)			

REV	DATE DESCRIPTION	REV BY:		PROJECT: CITY OF WEST BEND REGNER PARK	
	DATE DESCRIPTION 1-17-20 ISSUED FOR STATE PLAN REVIEW	REV BY:		C. CARL KUSS FIELD BASEBALL FACILITY	
			5662 Glendale Ave.	CITE OF WEST BEIND REGNER FARR	
			5662 Glendale Ave. Green Bay, WI 54313	C. CARL KUSS FIELD BASEBALL FACILITY CLIENT: WEST BEND BASEBALL ASSOCIATION	
			5662 Glendale Ave.	C. CARL KUSS FIELD BASEBALL FACILITY CLIENT: WEST BEND BASEBALL ASSOCIATION	

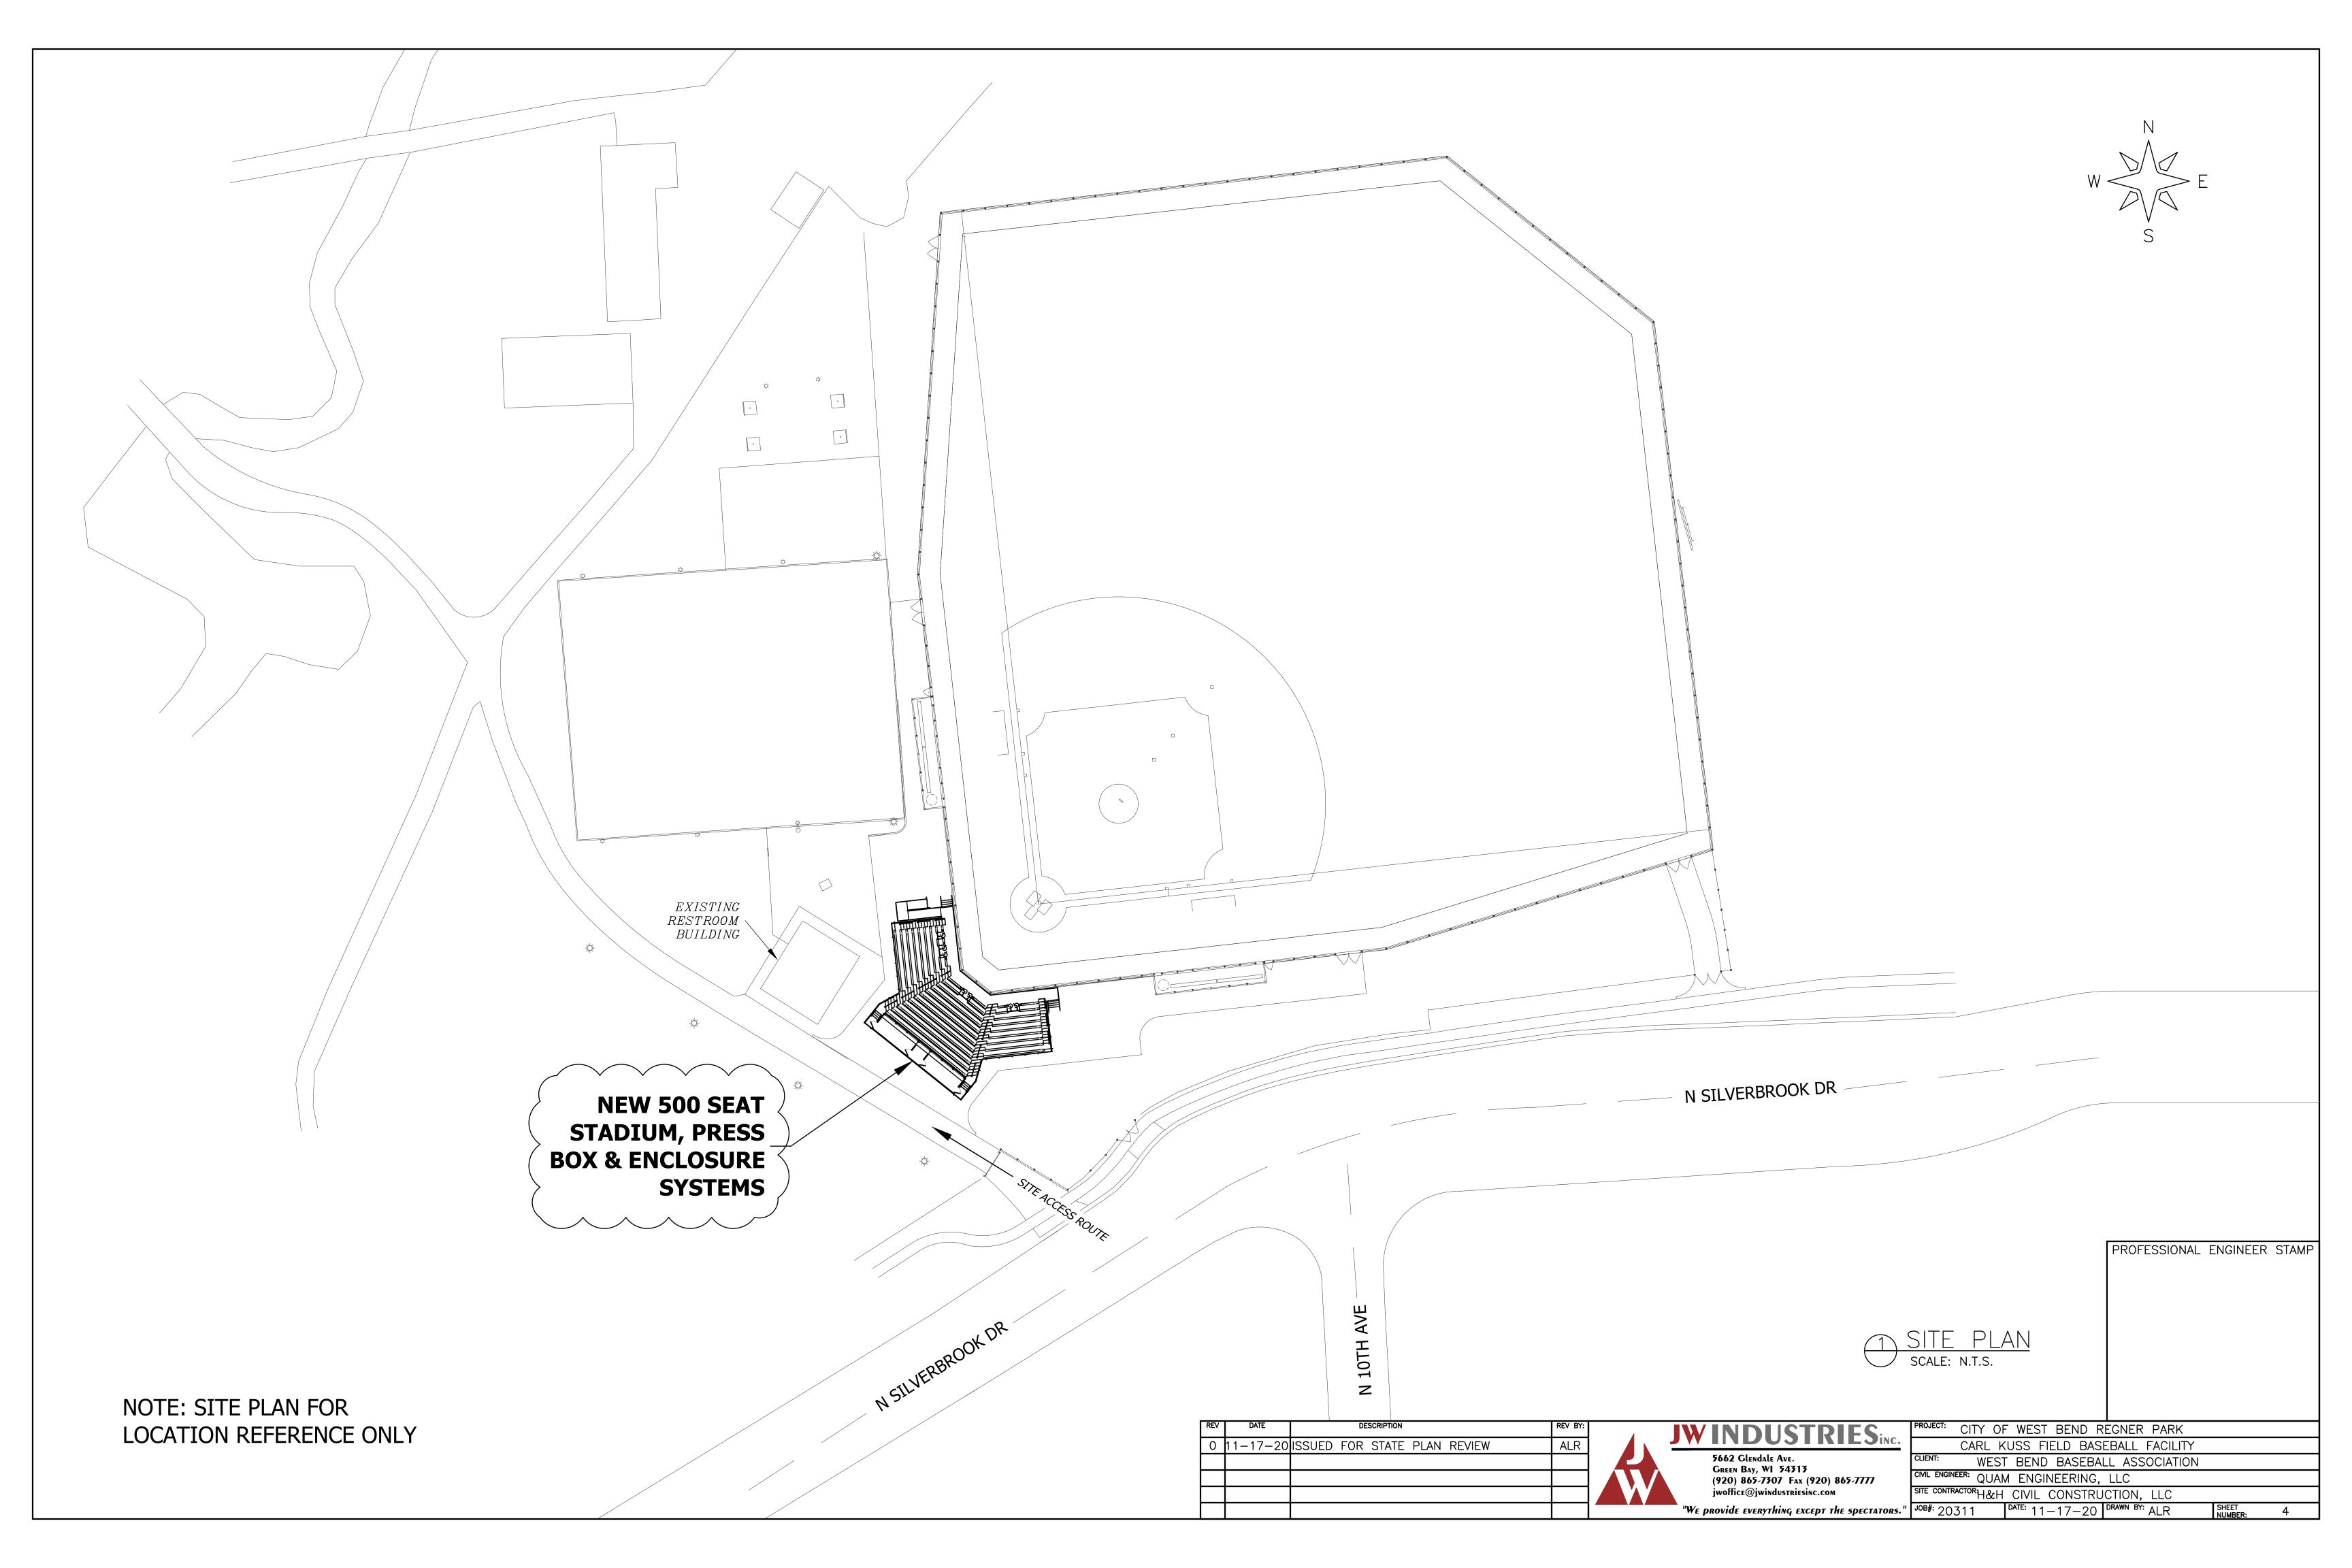


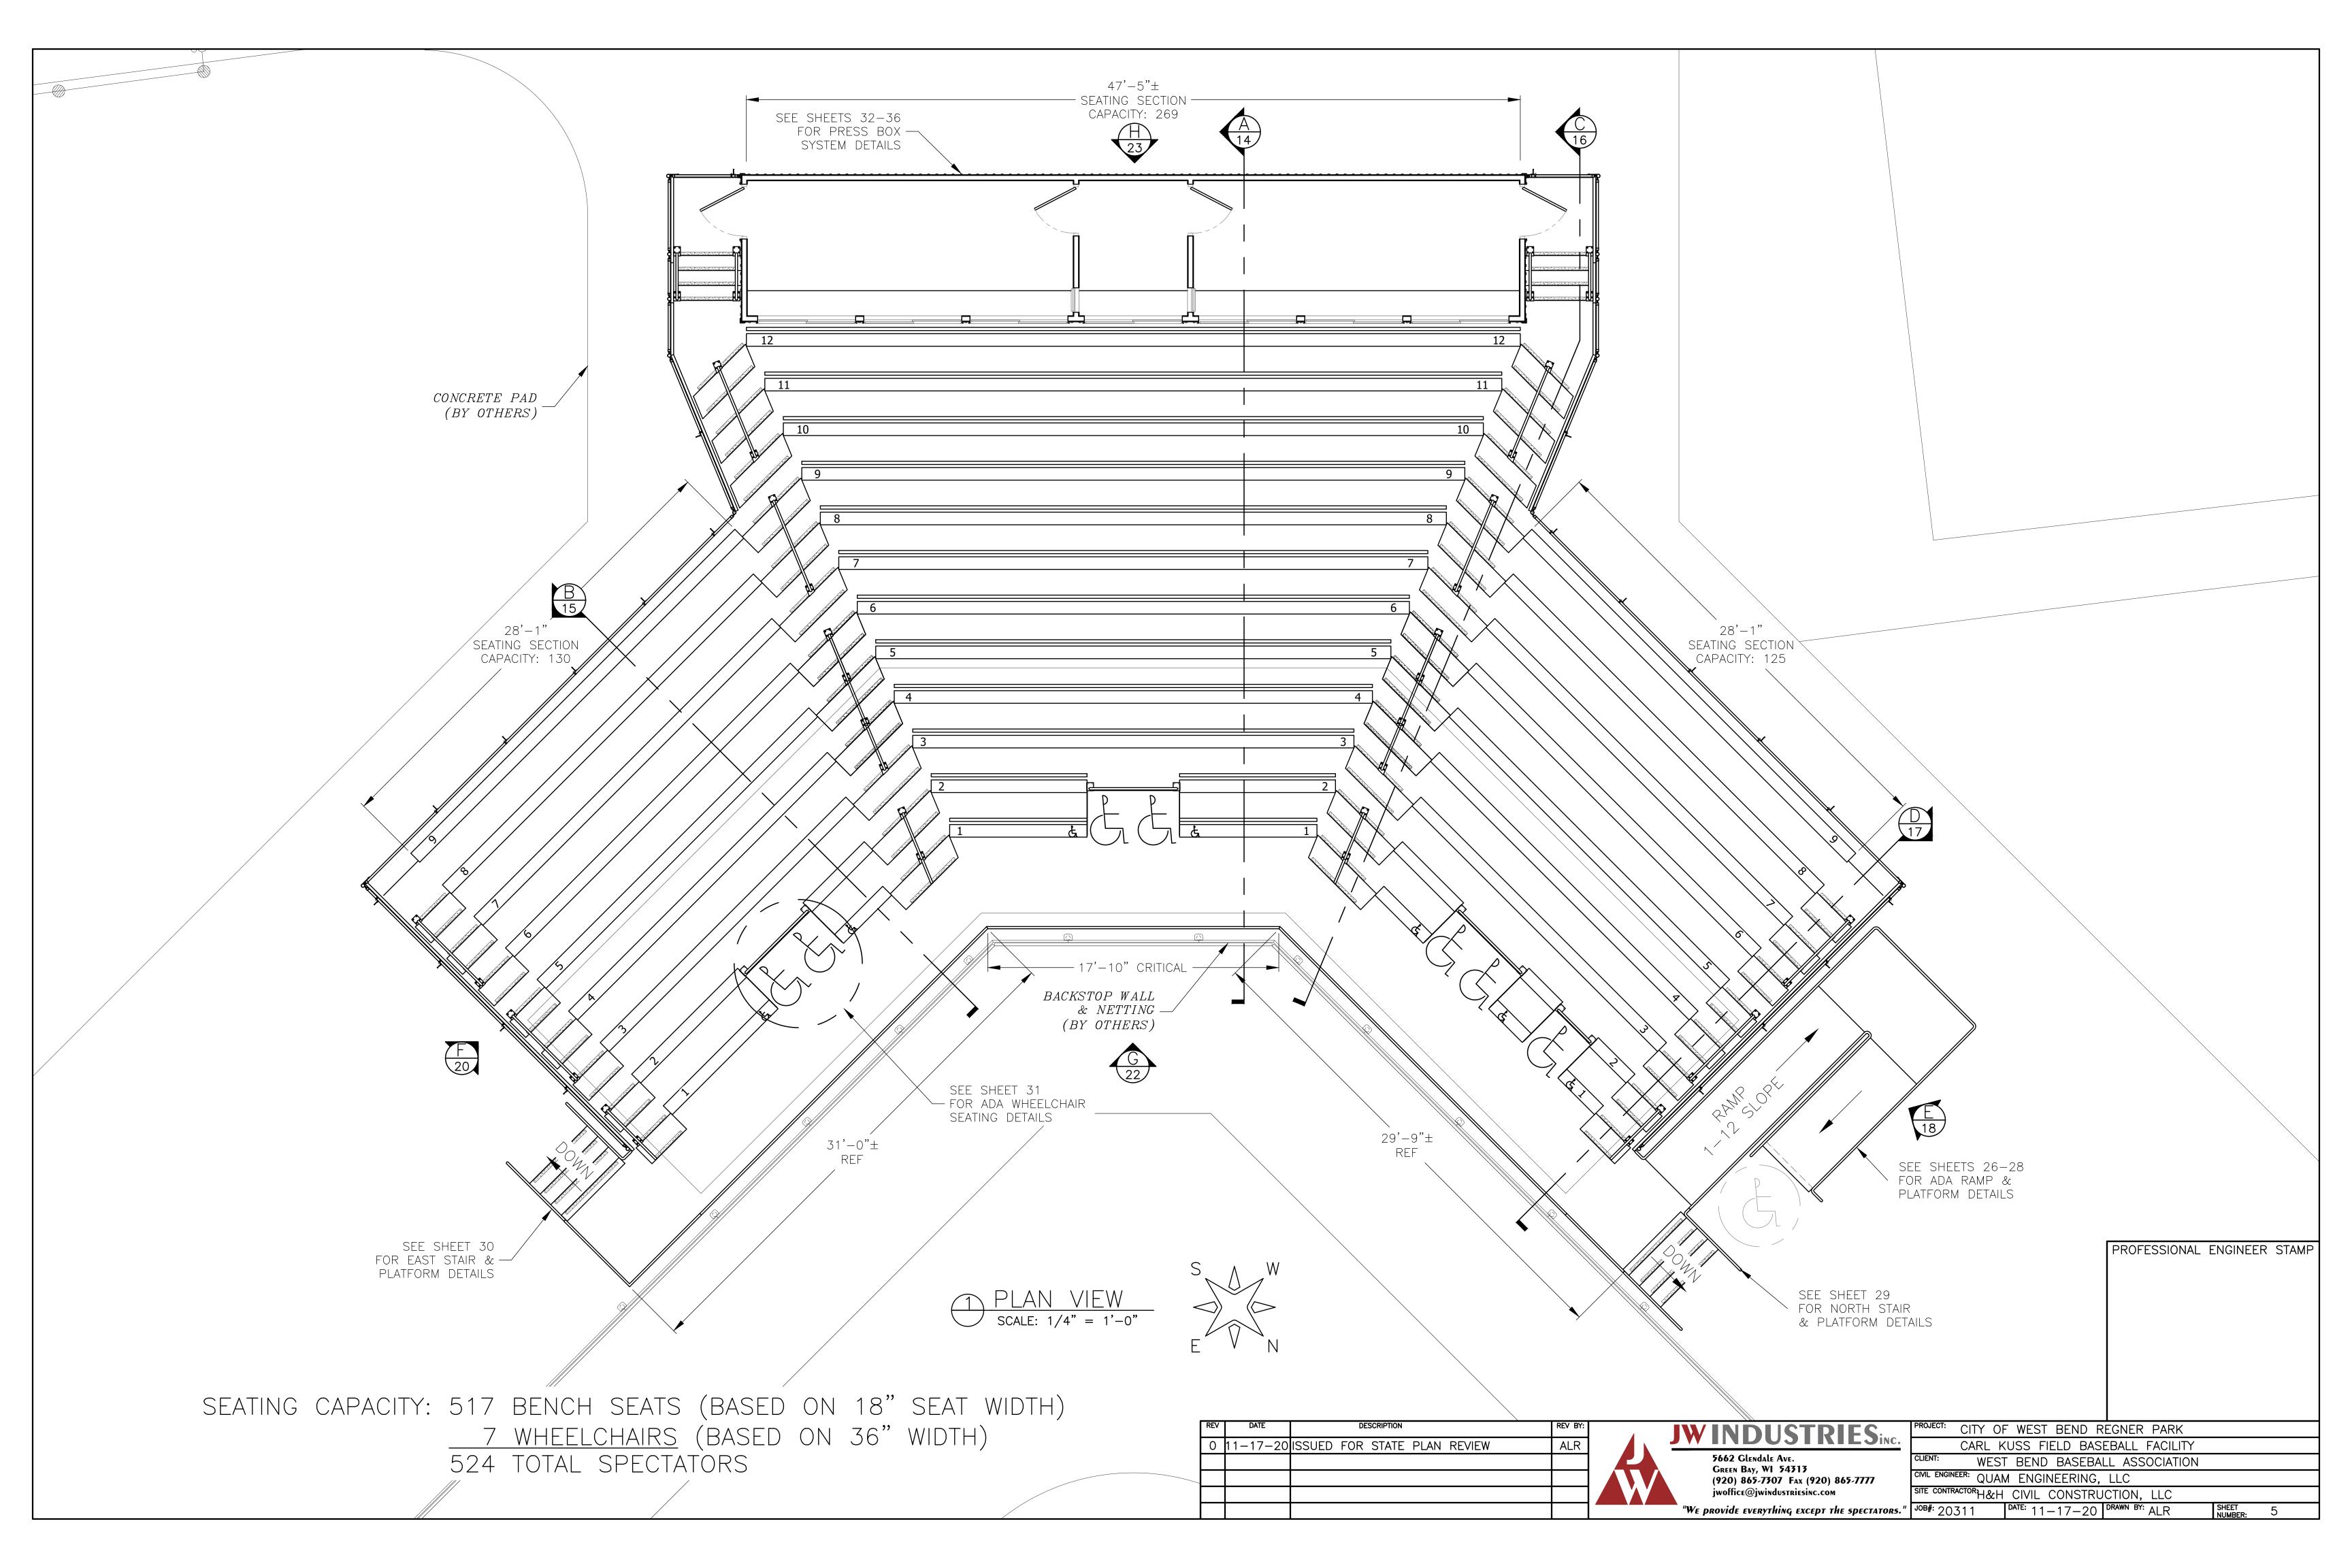


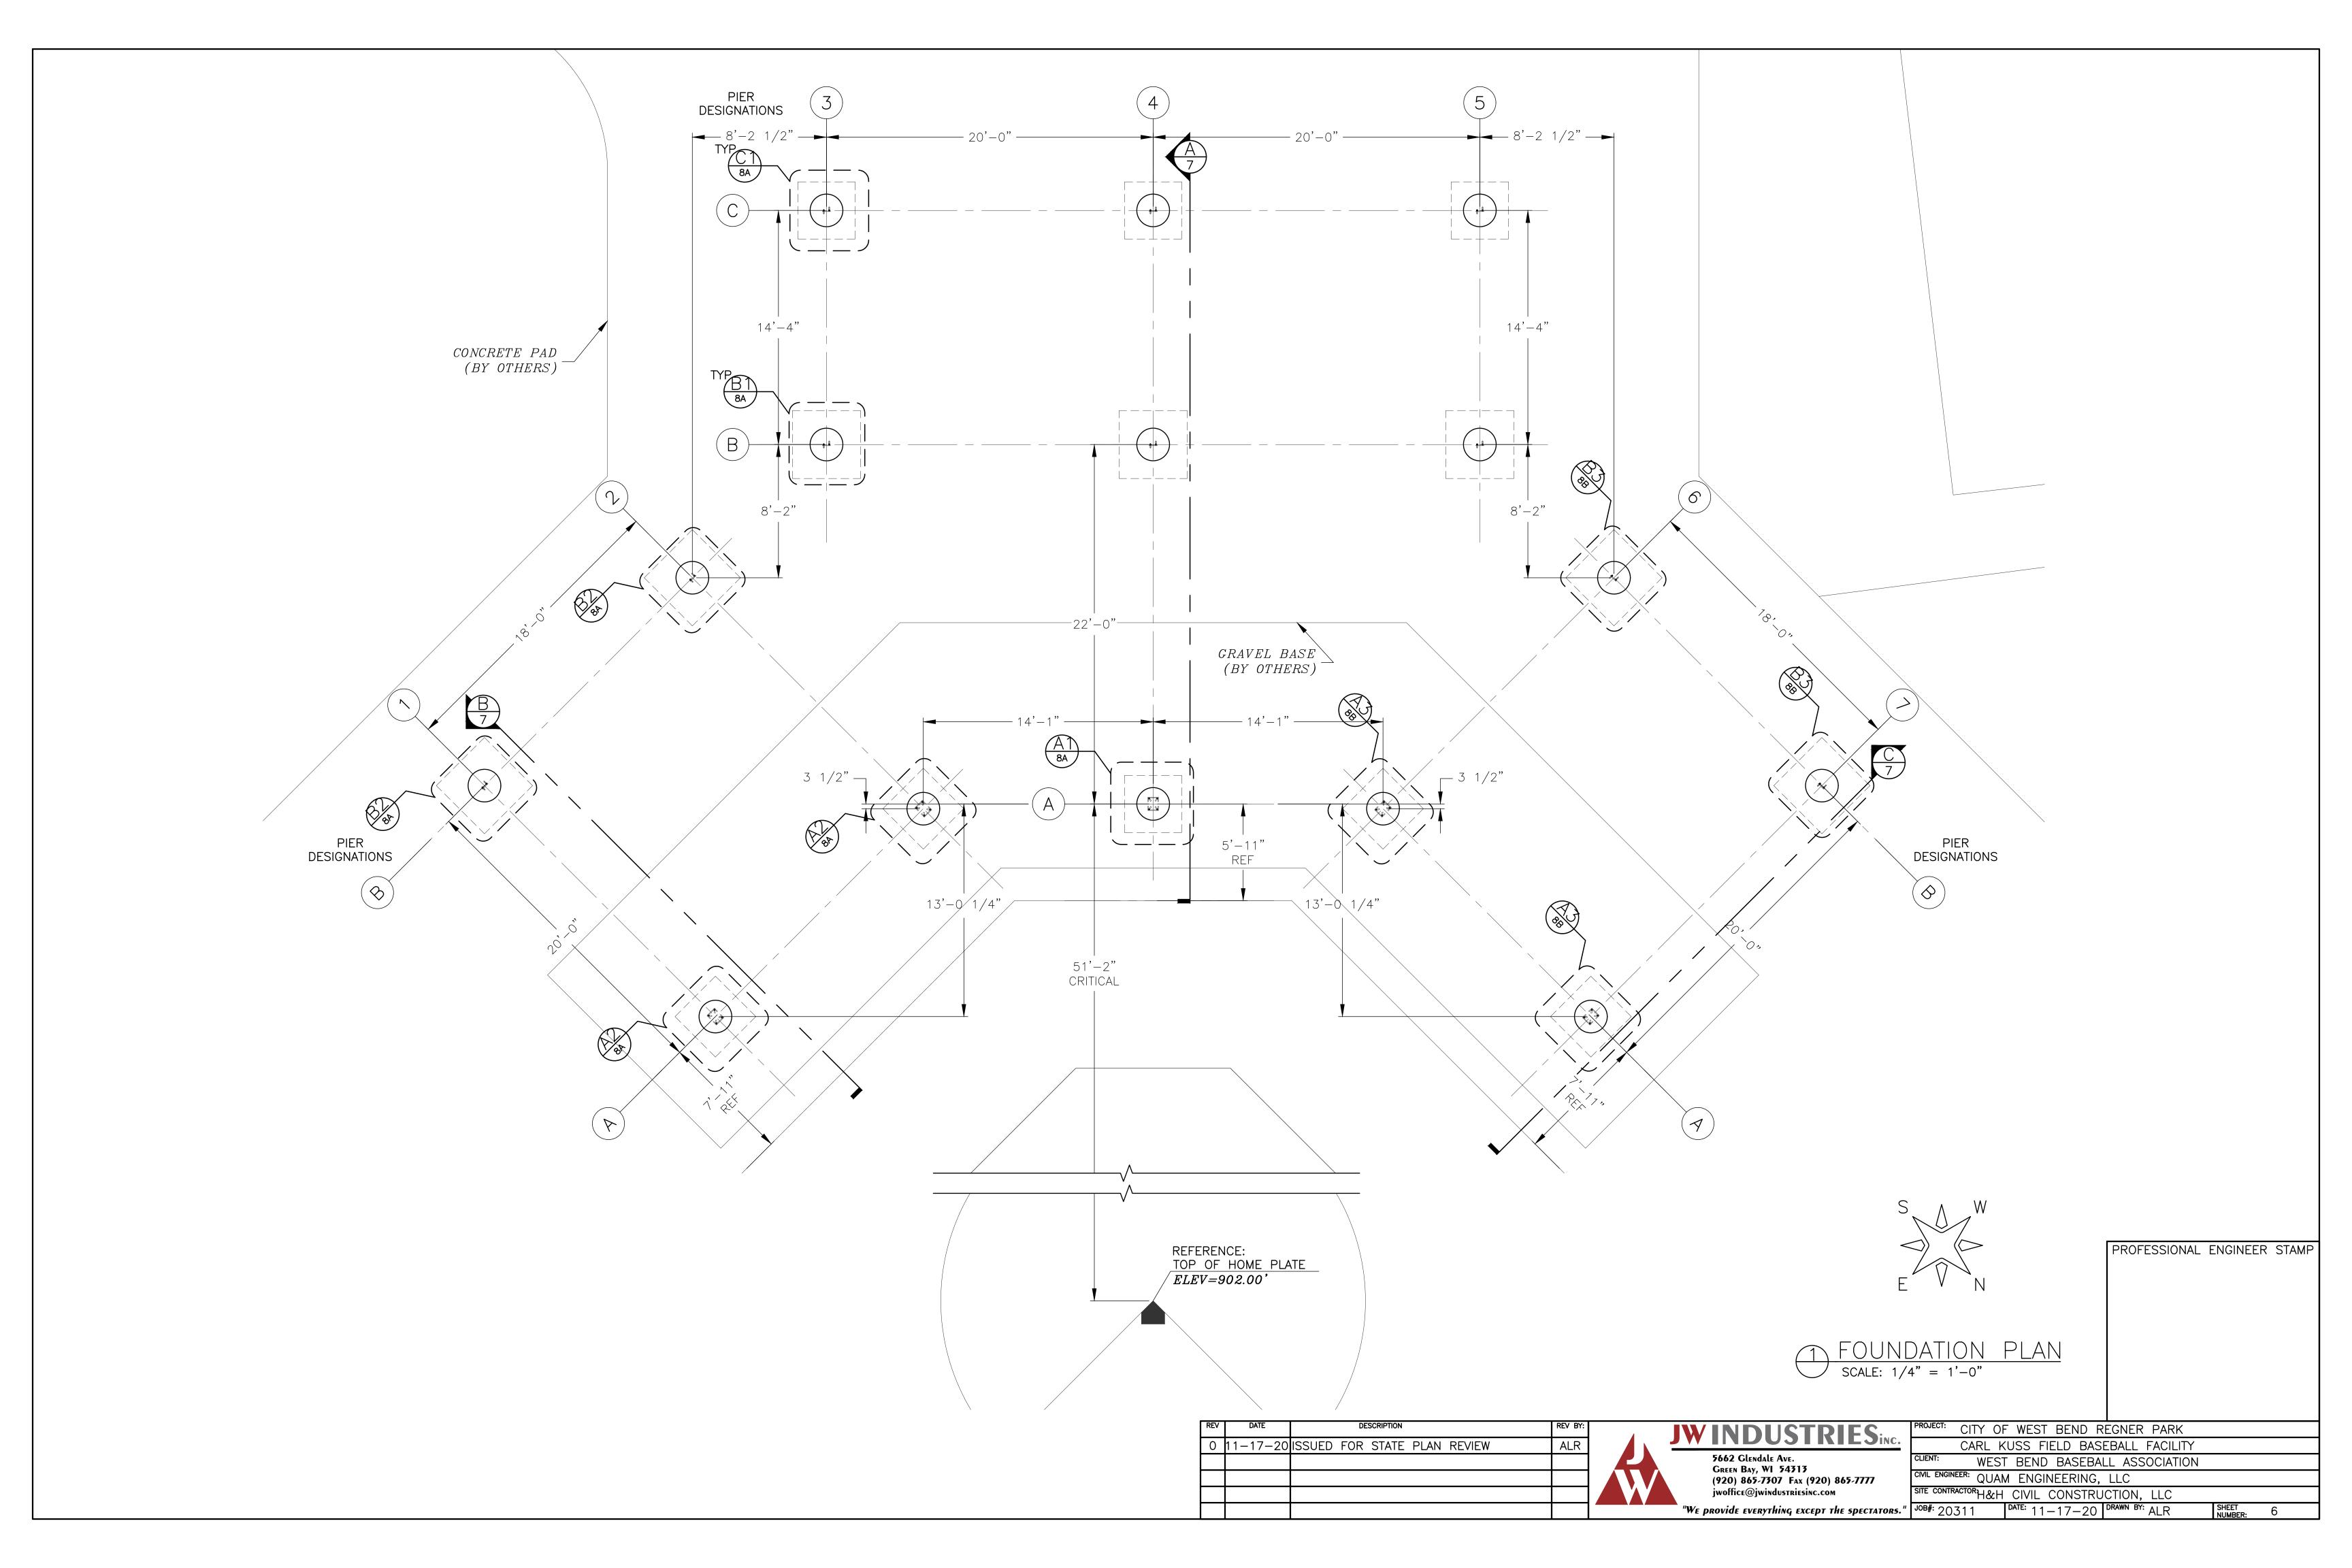

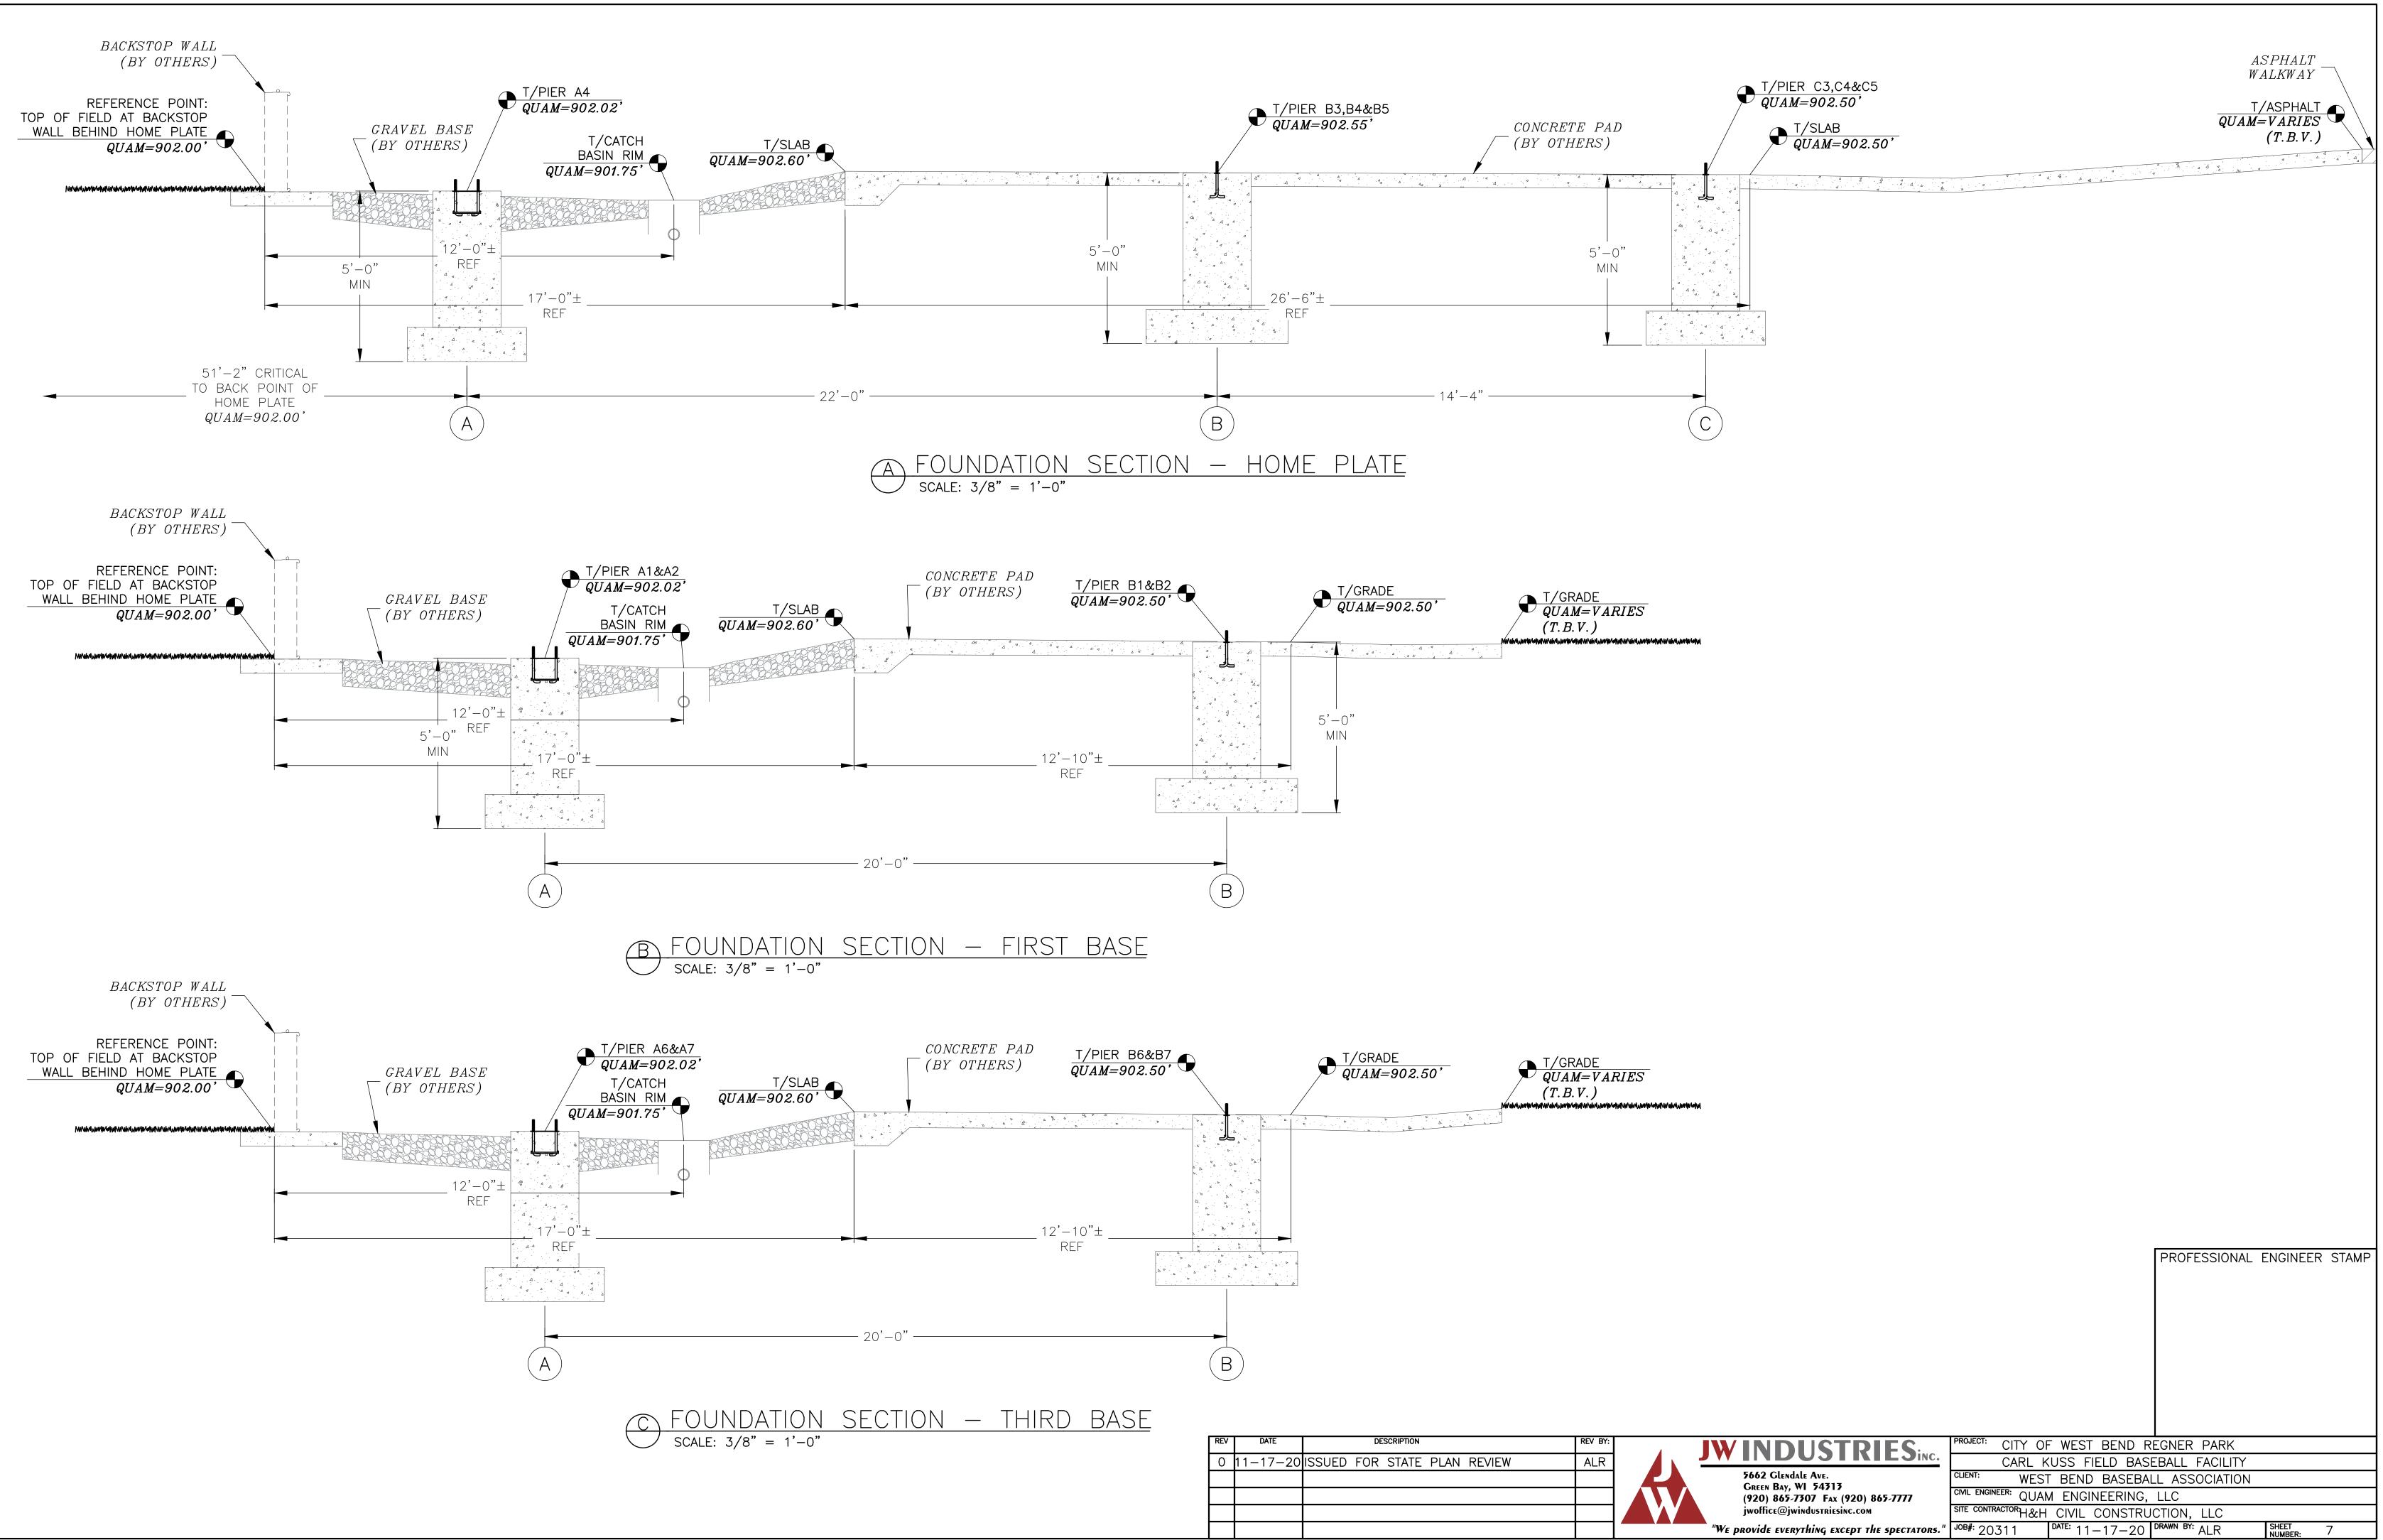



REV	DATE	DESCRIPTION	REV BY:	
0	11-17-20	ISSUED FOR STATE PLAN REVIEW	ALR	

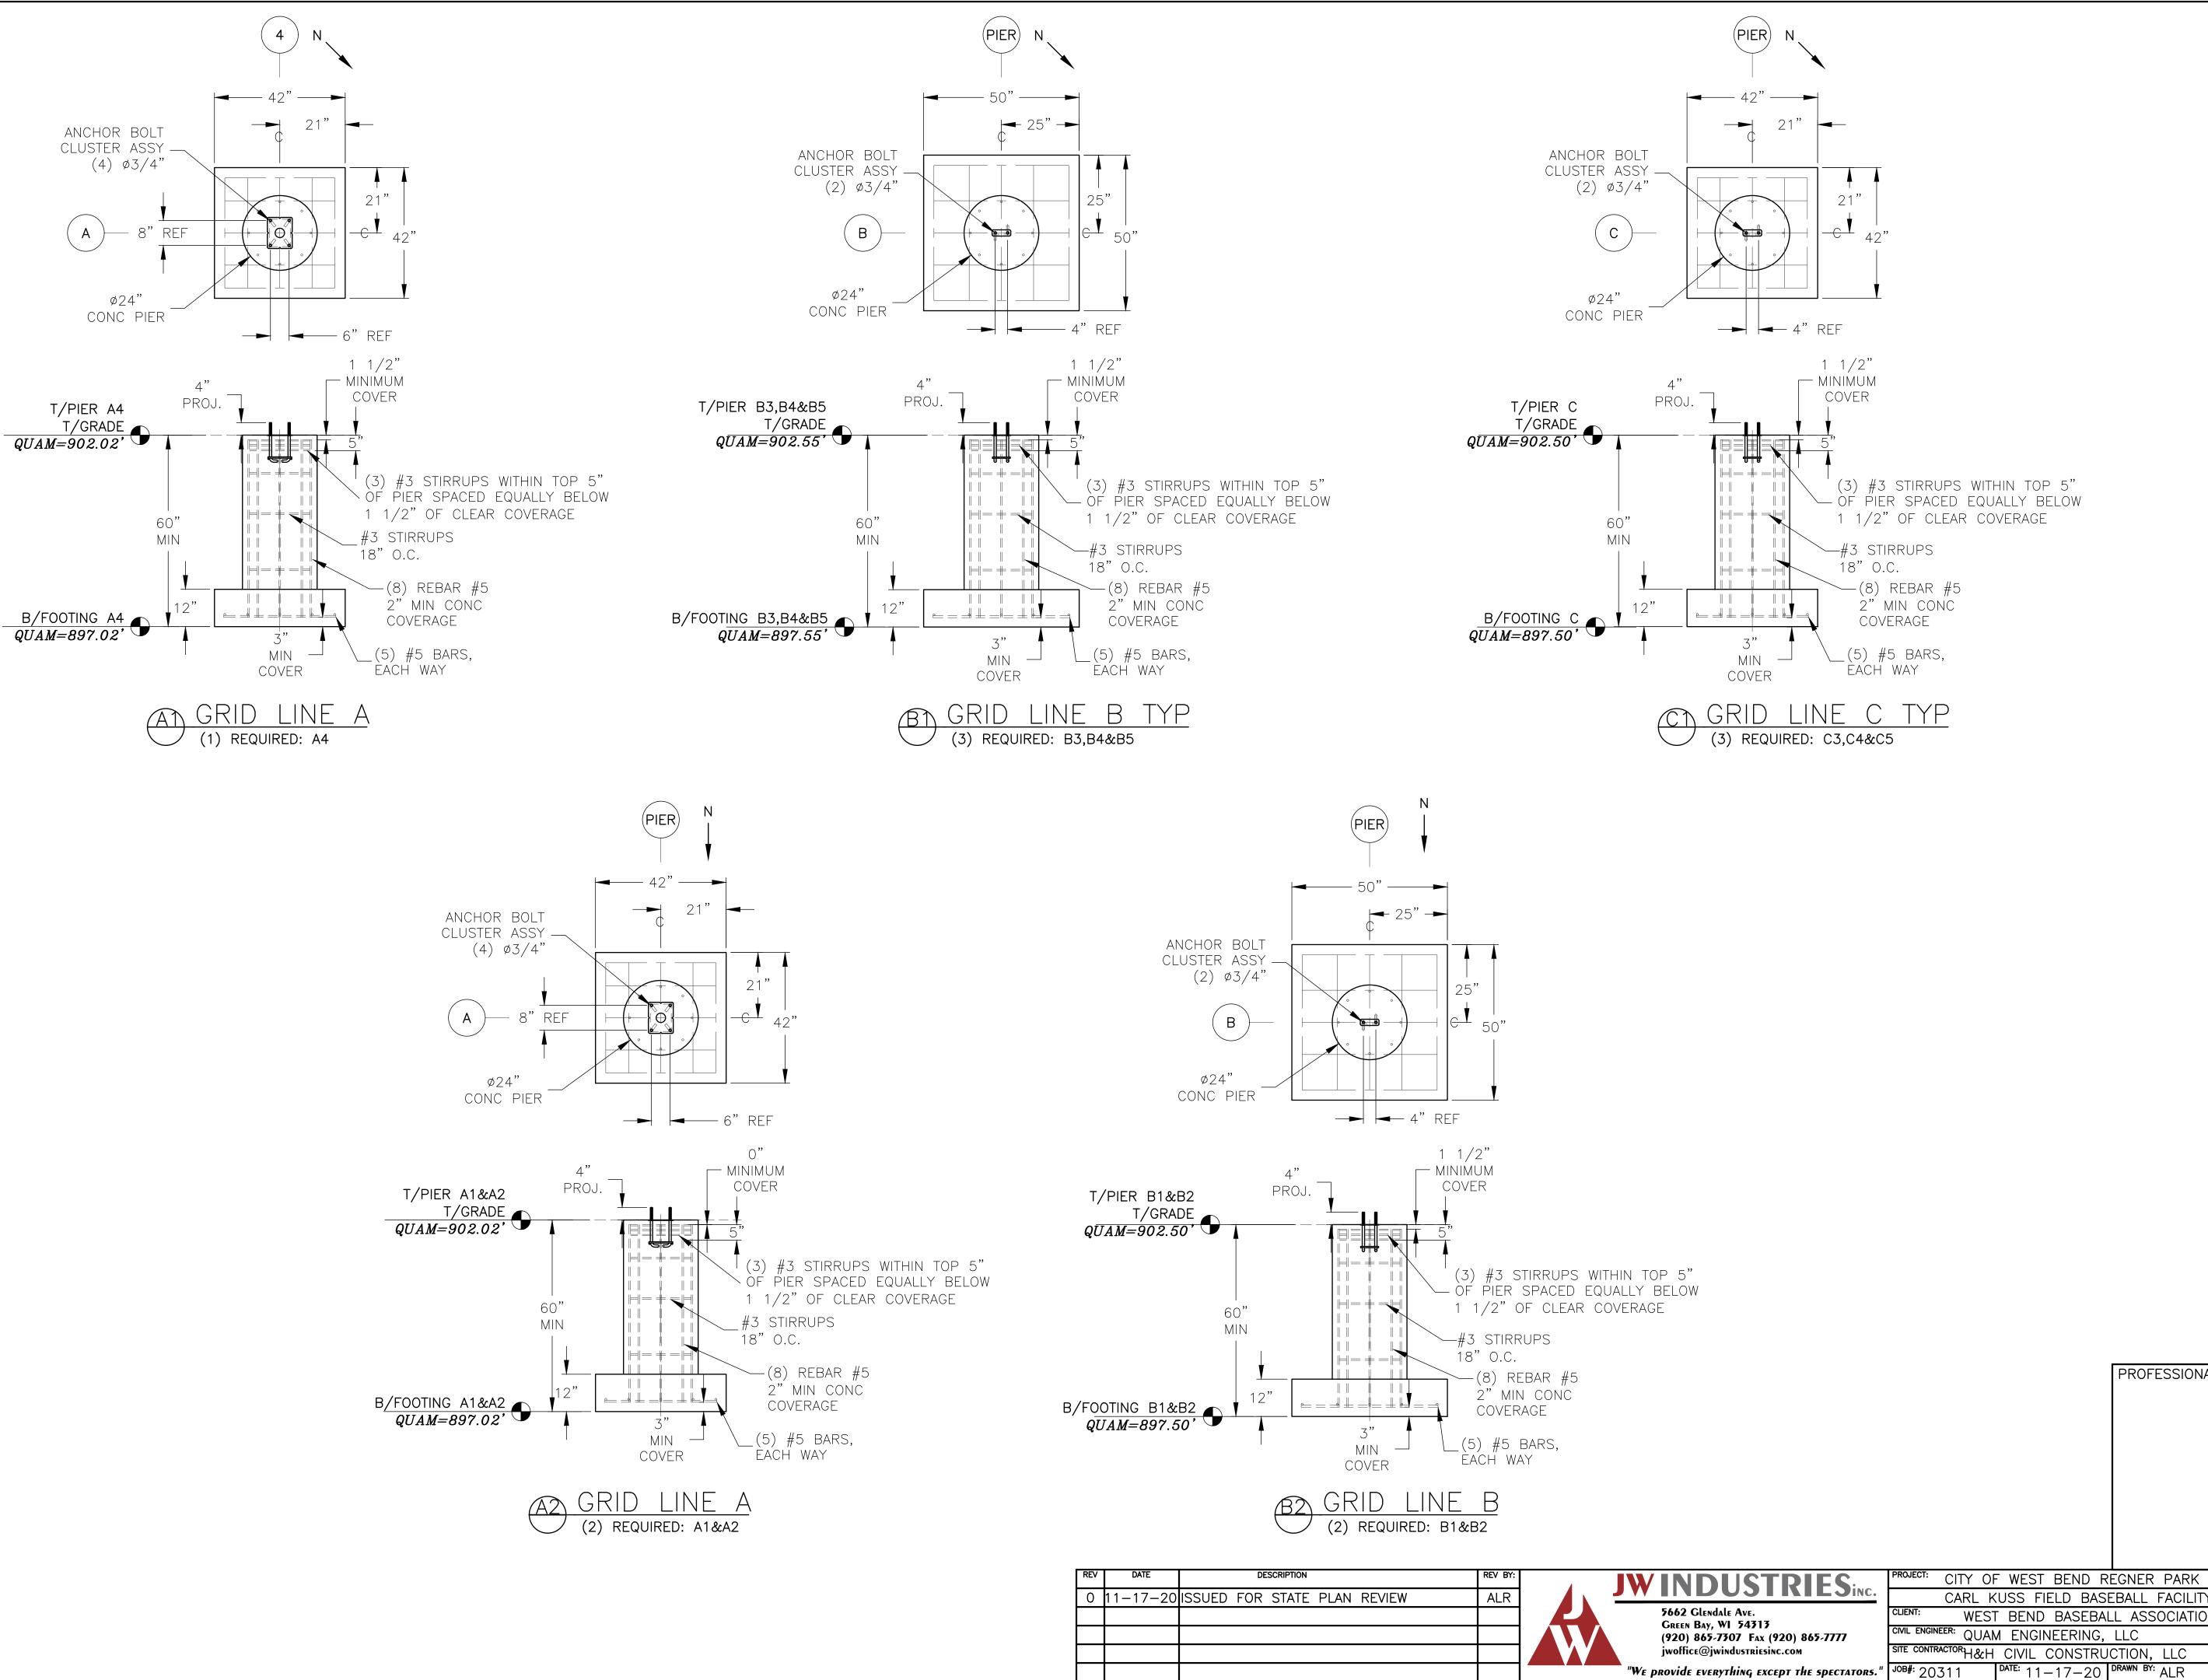


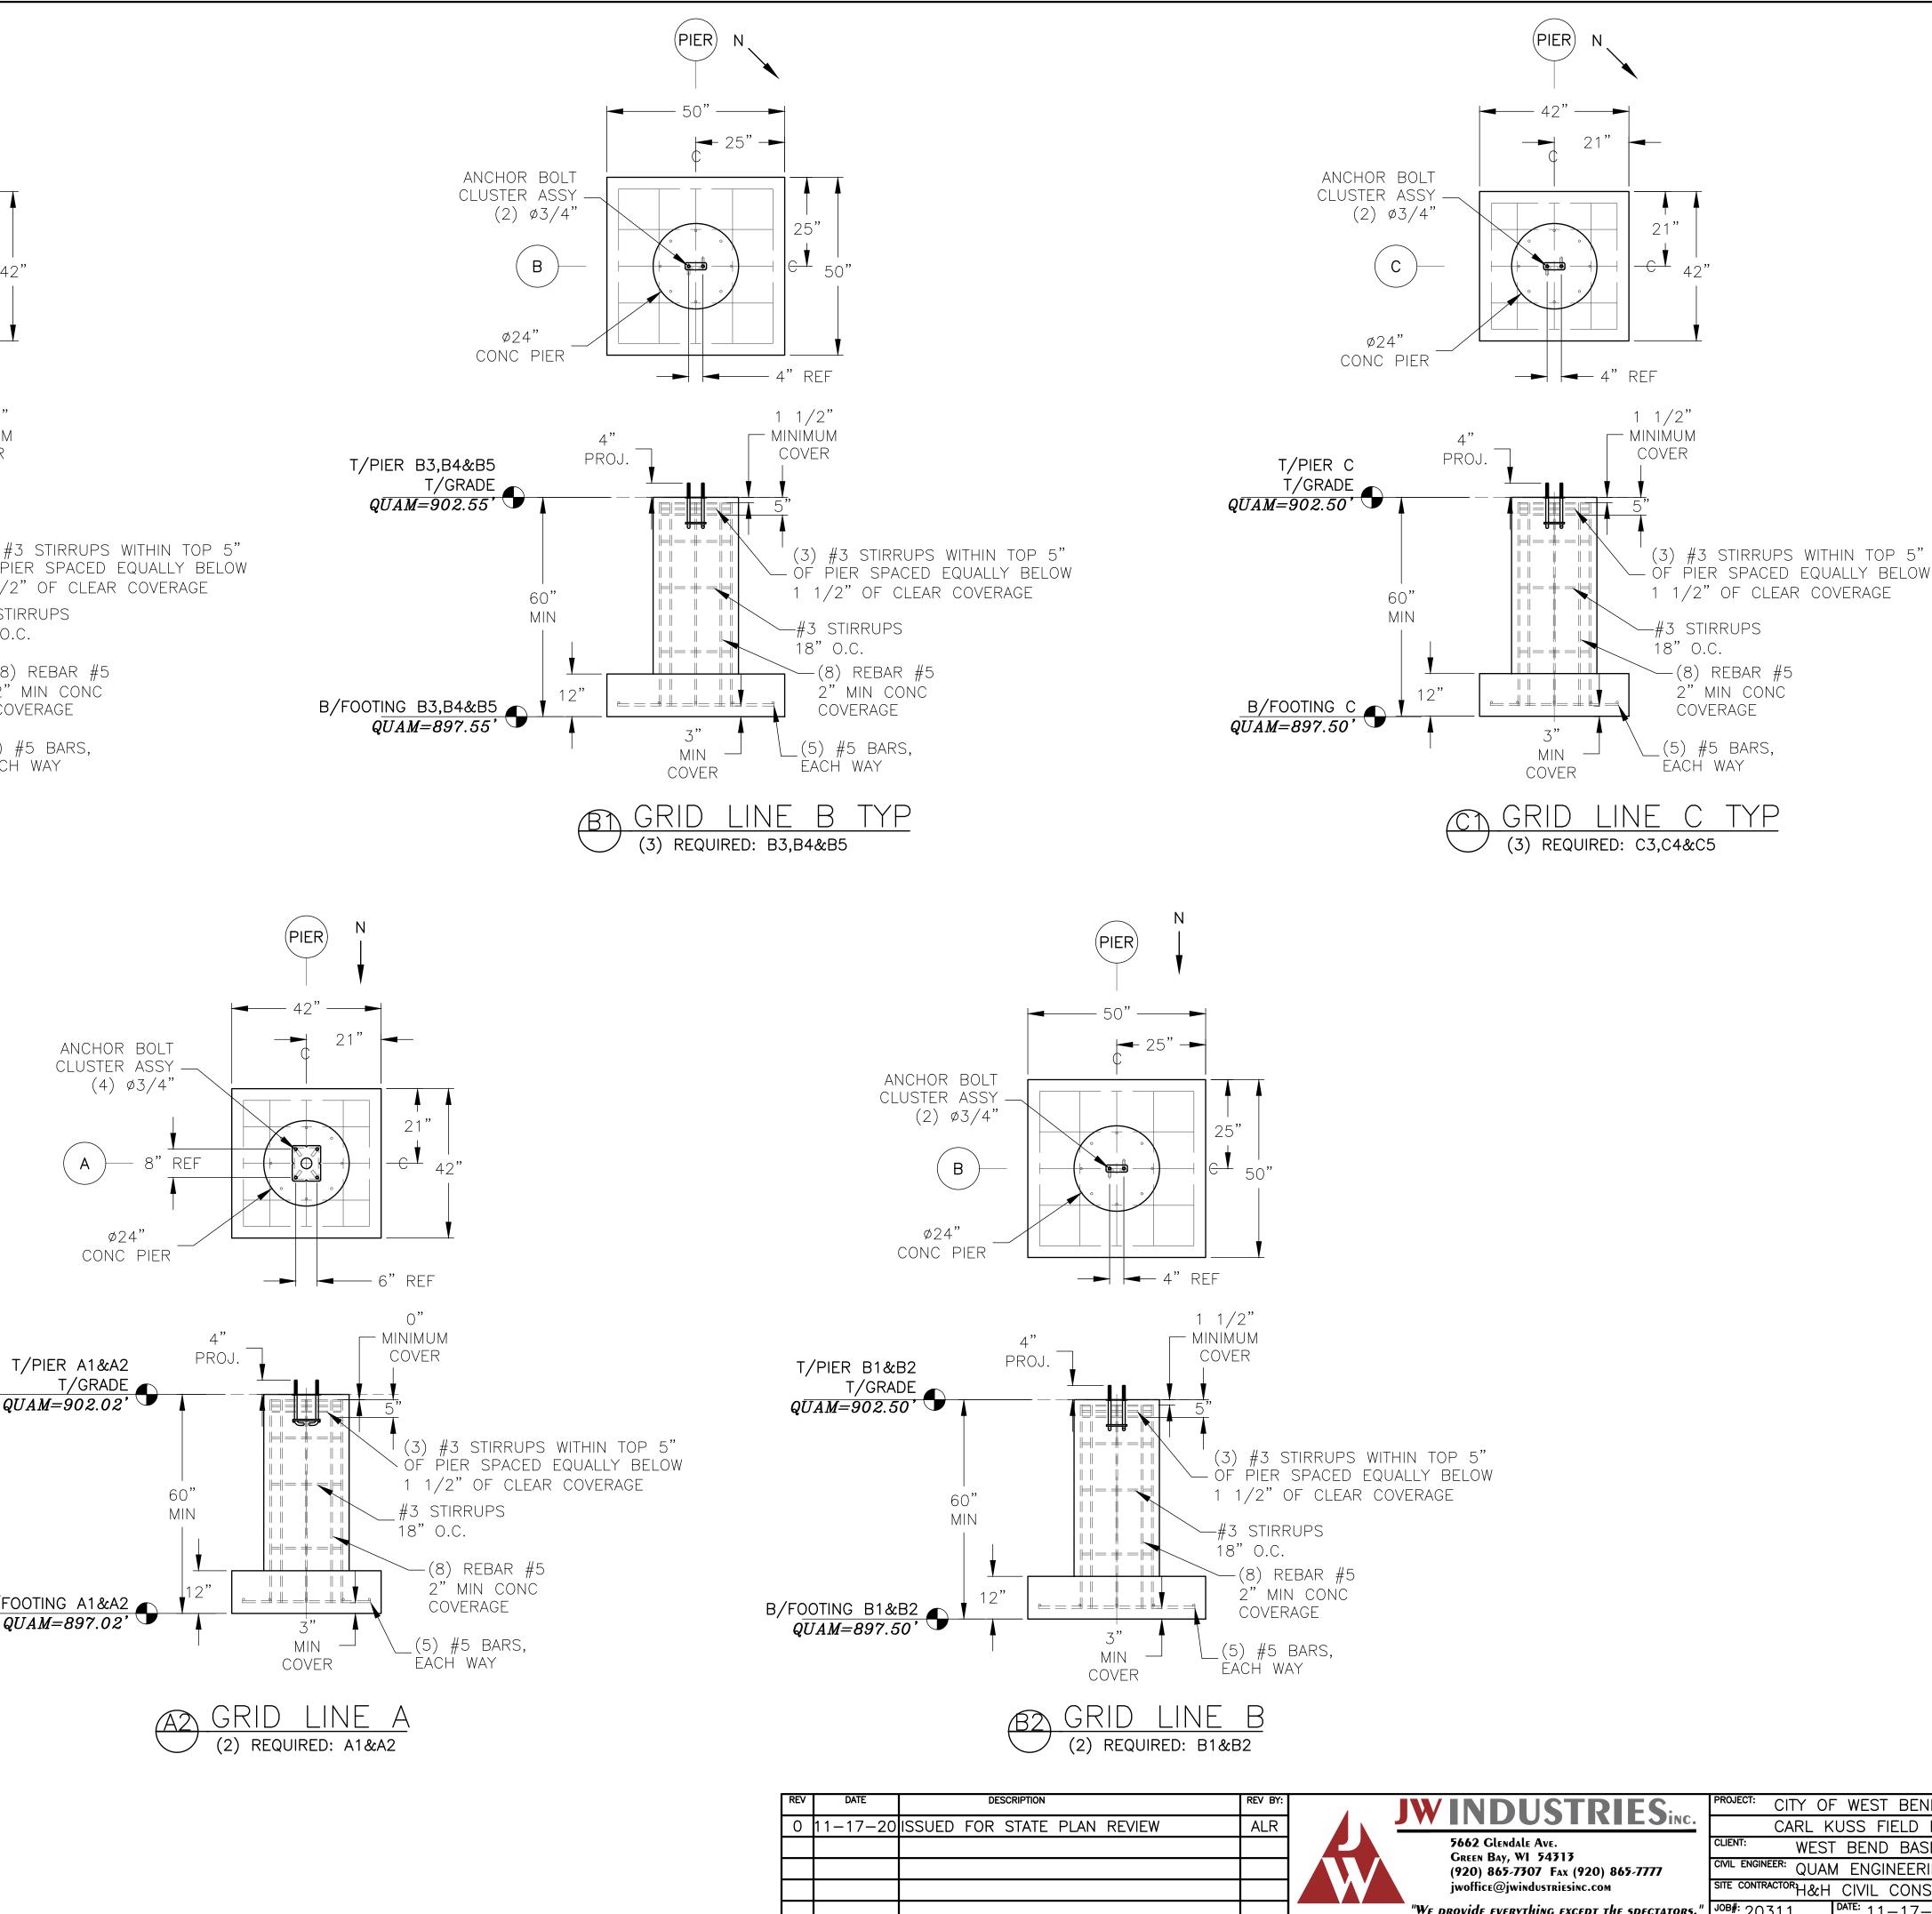

AR COVERAGE					
45 C			PROFESSIONAL	ENGINEER	STAMP
JWINDUSTRIES	PROJECT: CITY OF	F WEST BEND R			
5662 Glendale Ave. Green Bay, WI 54313	CLIENT: WEST	F BEND BASEBAL	L ASSOCIATION		
GREEN BAY, WI 54313 (920) 865-7307 Fax (920) 865-7777 jwoffice@jwindustriesinc.com	SITE CONTRACTOR	<u>A ENGINEERING,</u> CIVIL CONSTRU	CTION, LLC		
"We provide everything except the spectators."	<sup>јов#:</sup> 20311	date: 11-17-20	drawn by: ALR	SHEET NUMBER:	8A

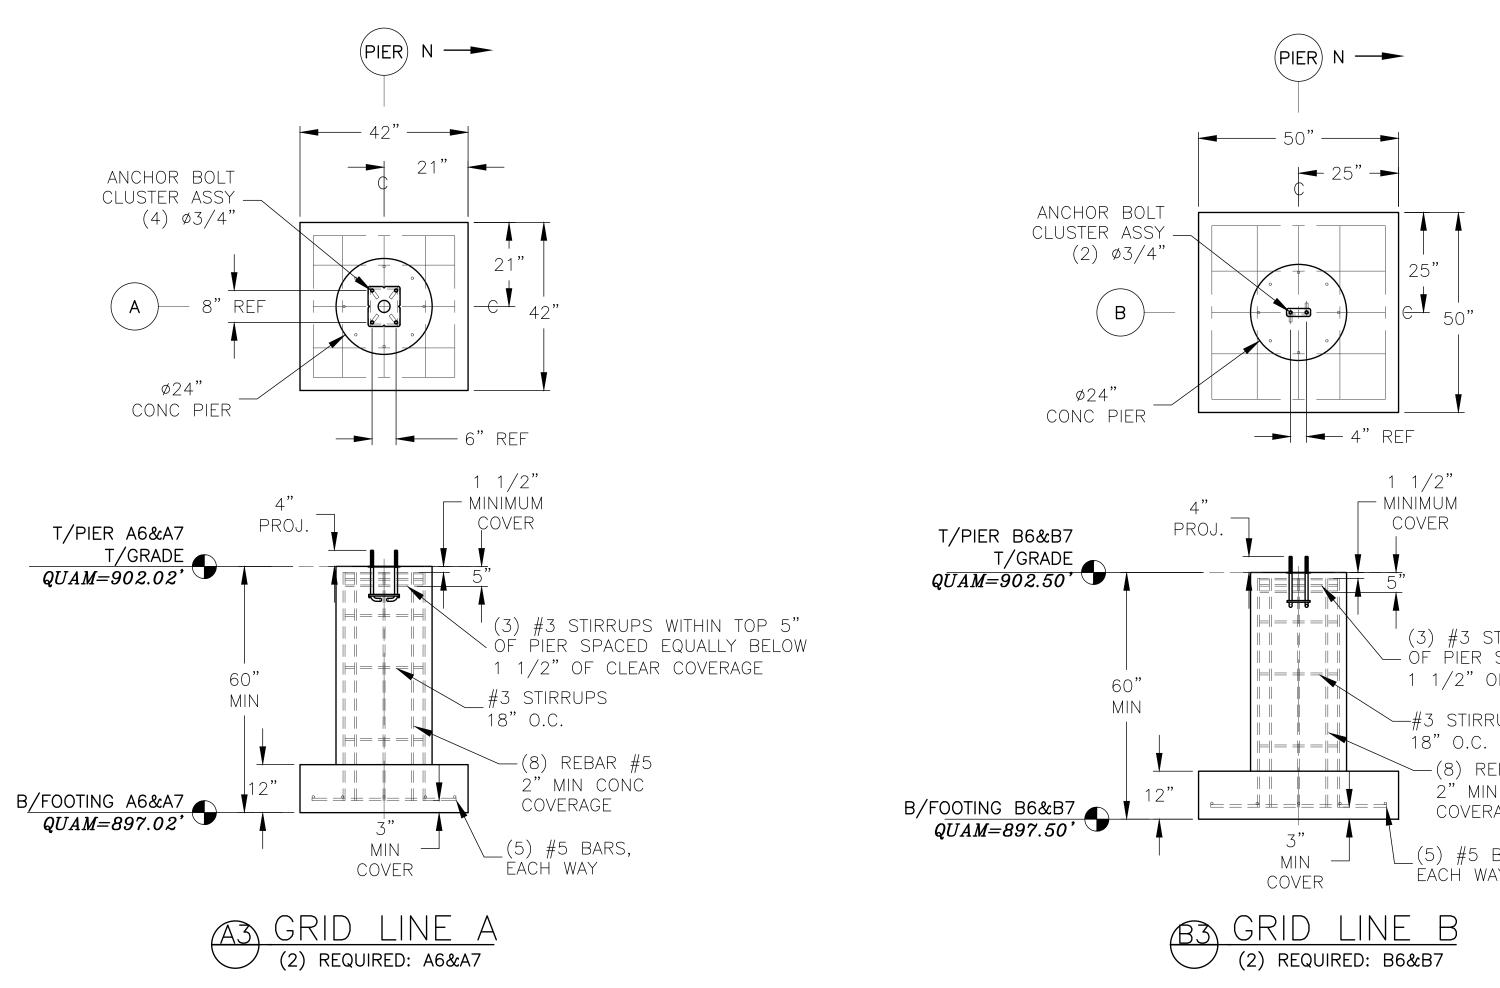

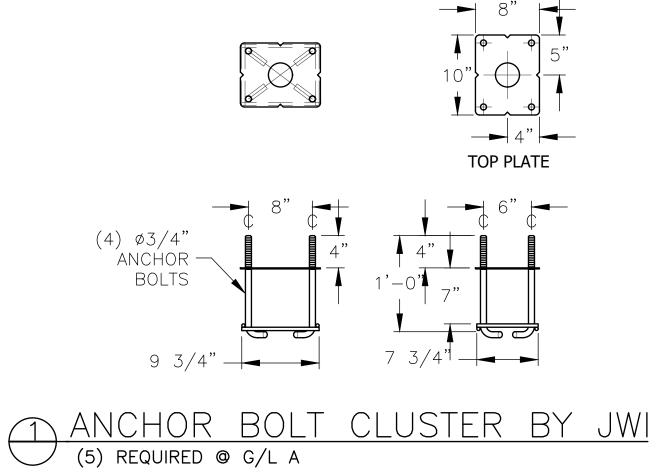

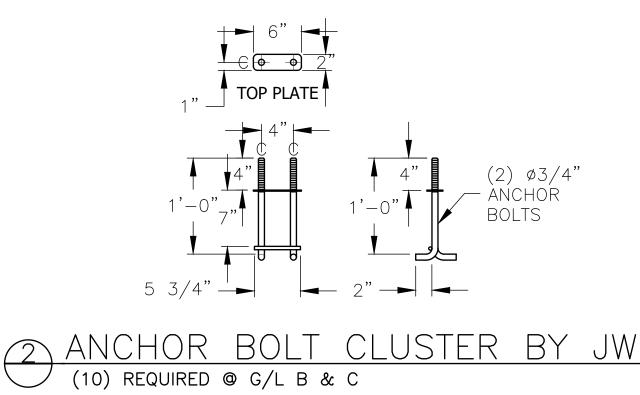


REV	DATE	DESCRIPTION	REV BY:	
0	11-17-20	ISSUED FOR STATE PLAN REVIEW	ALR	

(3) #3 STIRRUPS WITHIN TOP 5" OF PIER SPACED EQUALLY BELOW 1 1/2" OF CLEAR COVERAGE


—#3 STIRRUPS — (8) REBAR #5 2" MIN CONC COVERAGE


\_(5) #5 BARS, EACH WAY


$\sqrt{ }$				PROFESSIONAL	ENGINEER	STAMP
		PROJECT: OITY OF				
	JWINDUSTRIES	PROJECT: CITY OF	F WEST BEND RE	EGNER PARK		
		CARL K	USS FIELD BASE	BALL FACILITY		
		CLIENT: WEST	- BEND BASEBAL	L ASSOCIATION		
	Green Bay, WI 54313 (920) 865-7307 Fax (920) 865-7777	CIVIL ENGINEER: QUAN	I ENGINEERING,	LLC		
	jwoffice@jwindustriesinc.com		CIVIL CONSTRUC			
	"We provide everything except the spectators."	<sup>јов#:</sup> 20311	DATE: 11-17-20	DRAWN BY: ALR	SHEET NUMBER:	8B

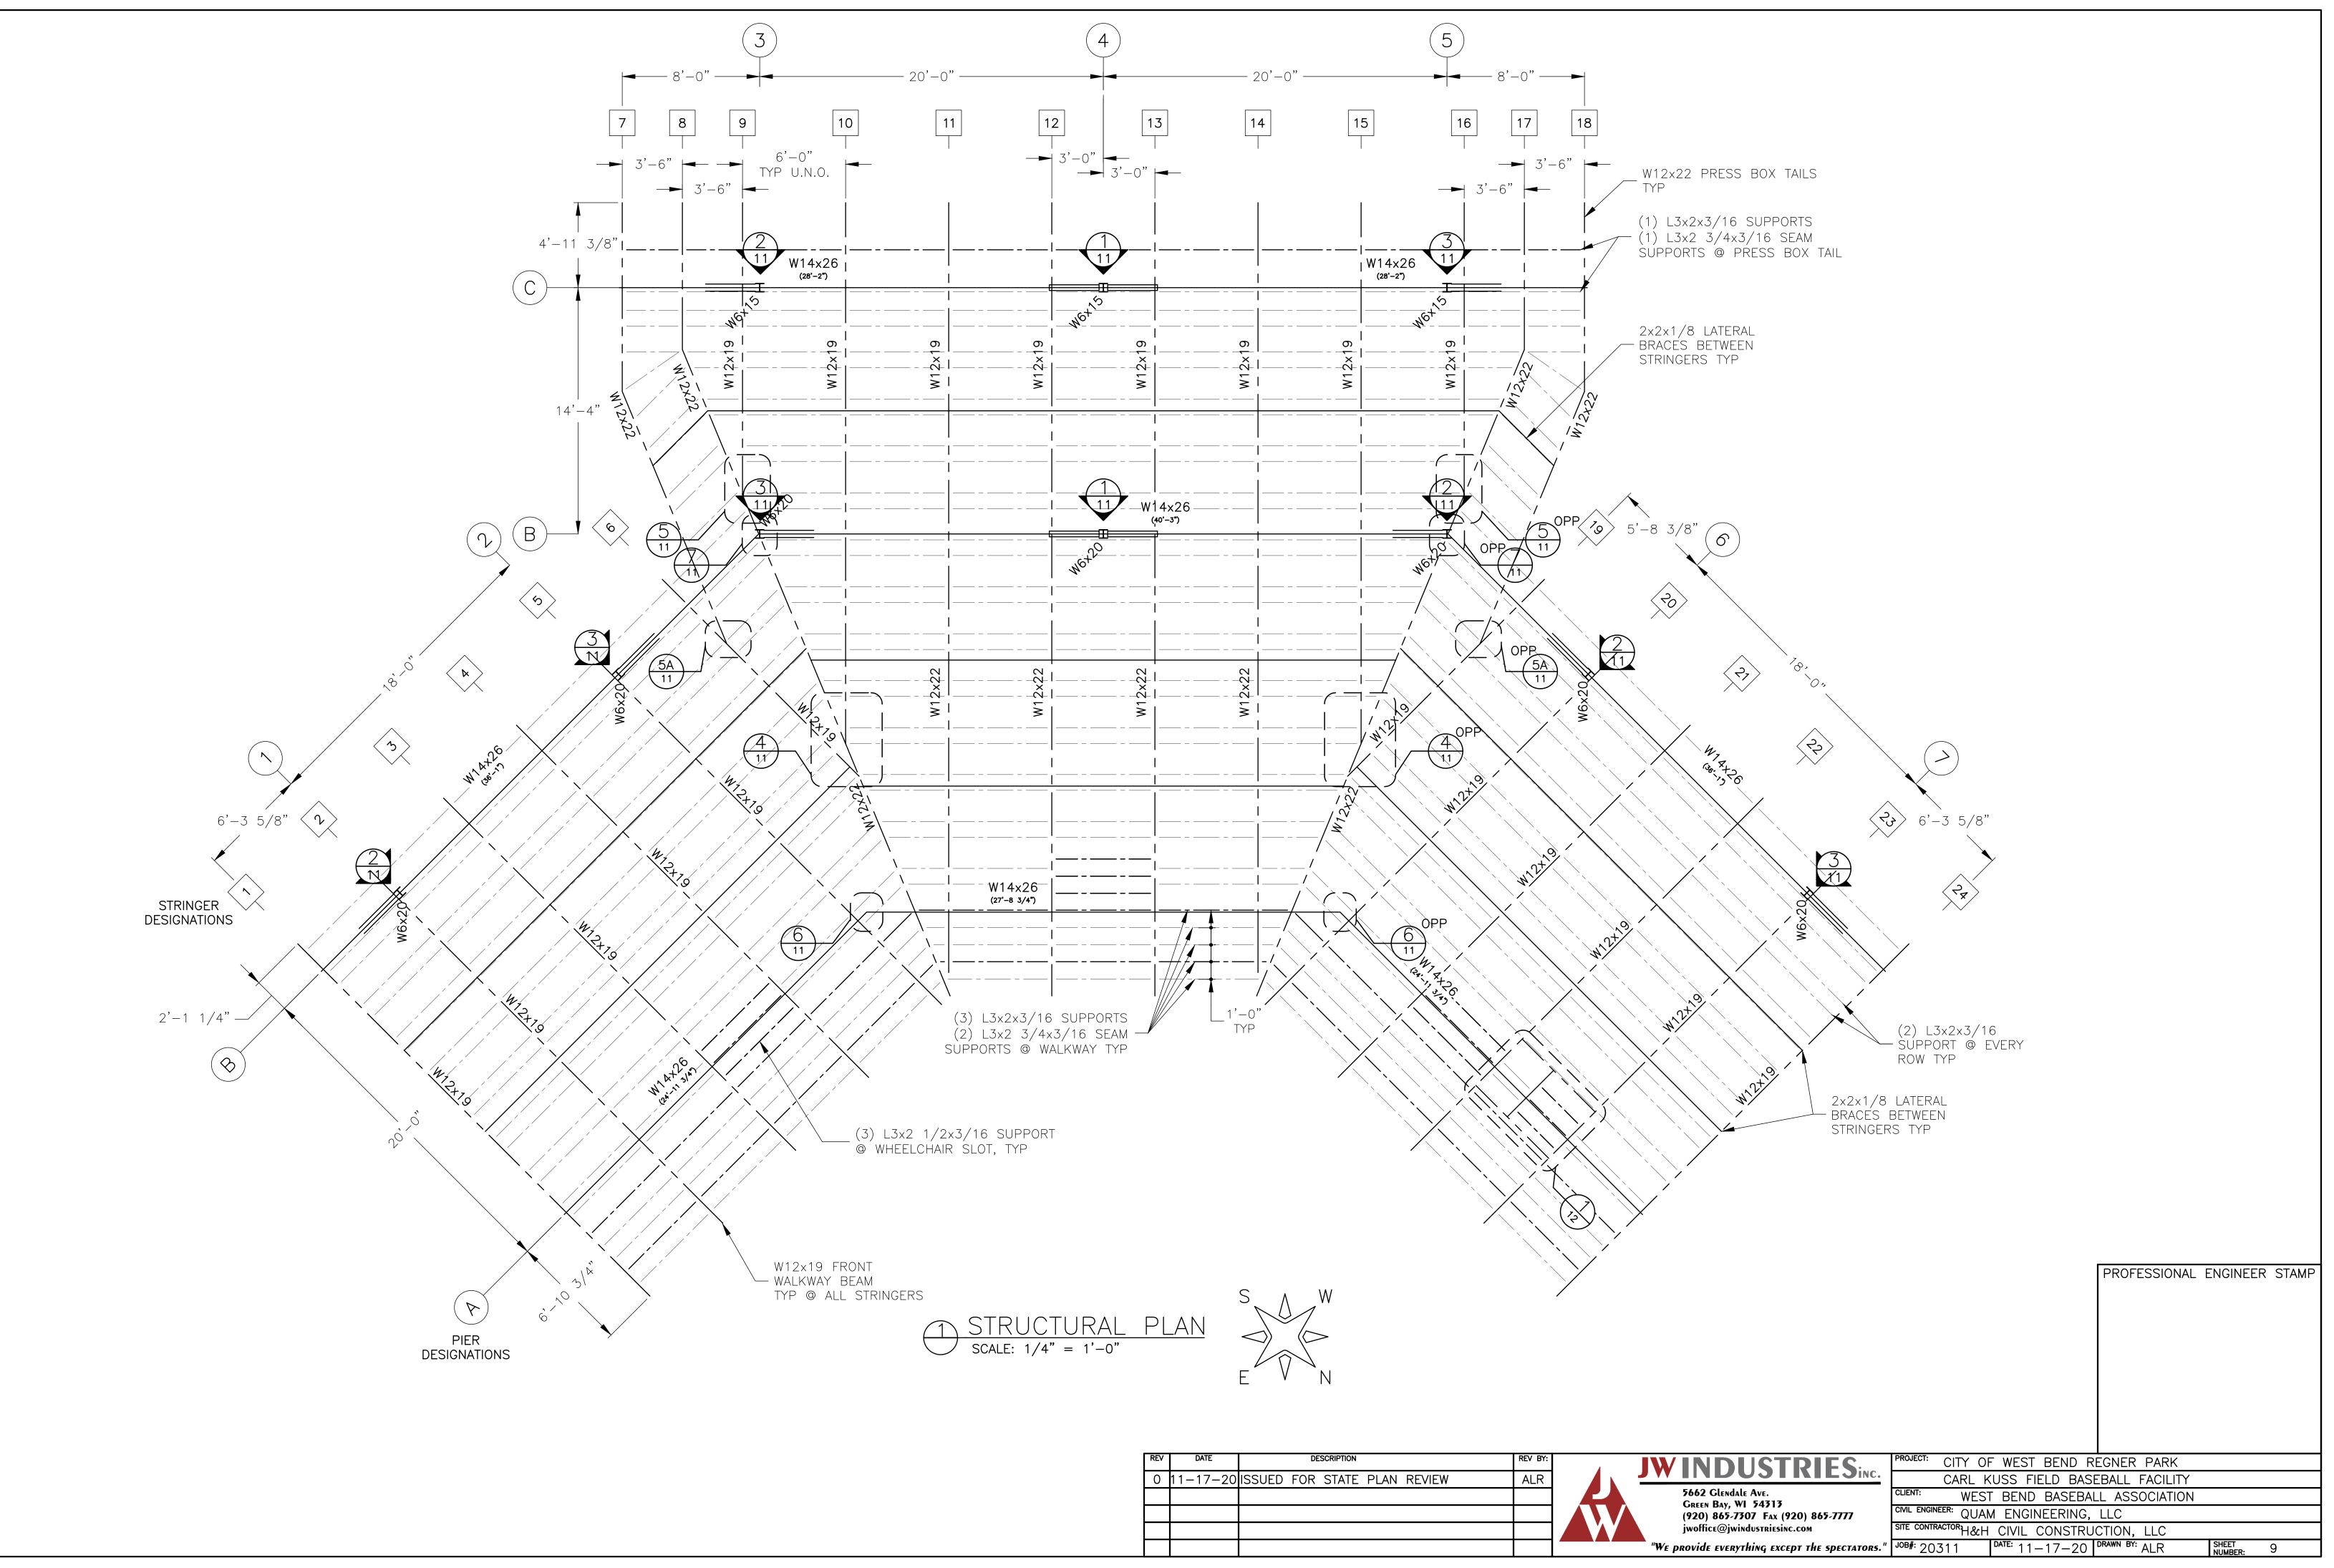

REV	DATE	DESCRIPTION	REV BY:	
0	11-17-20	ISSUED FOR STATE PLAN REVIEW	ALR	

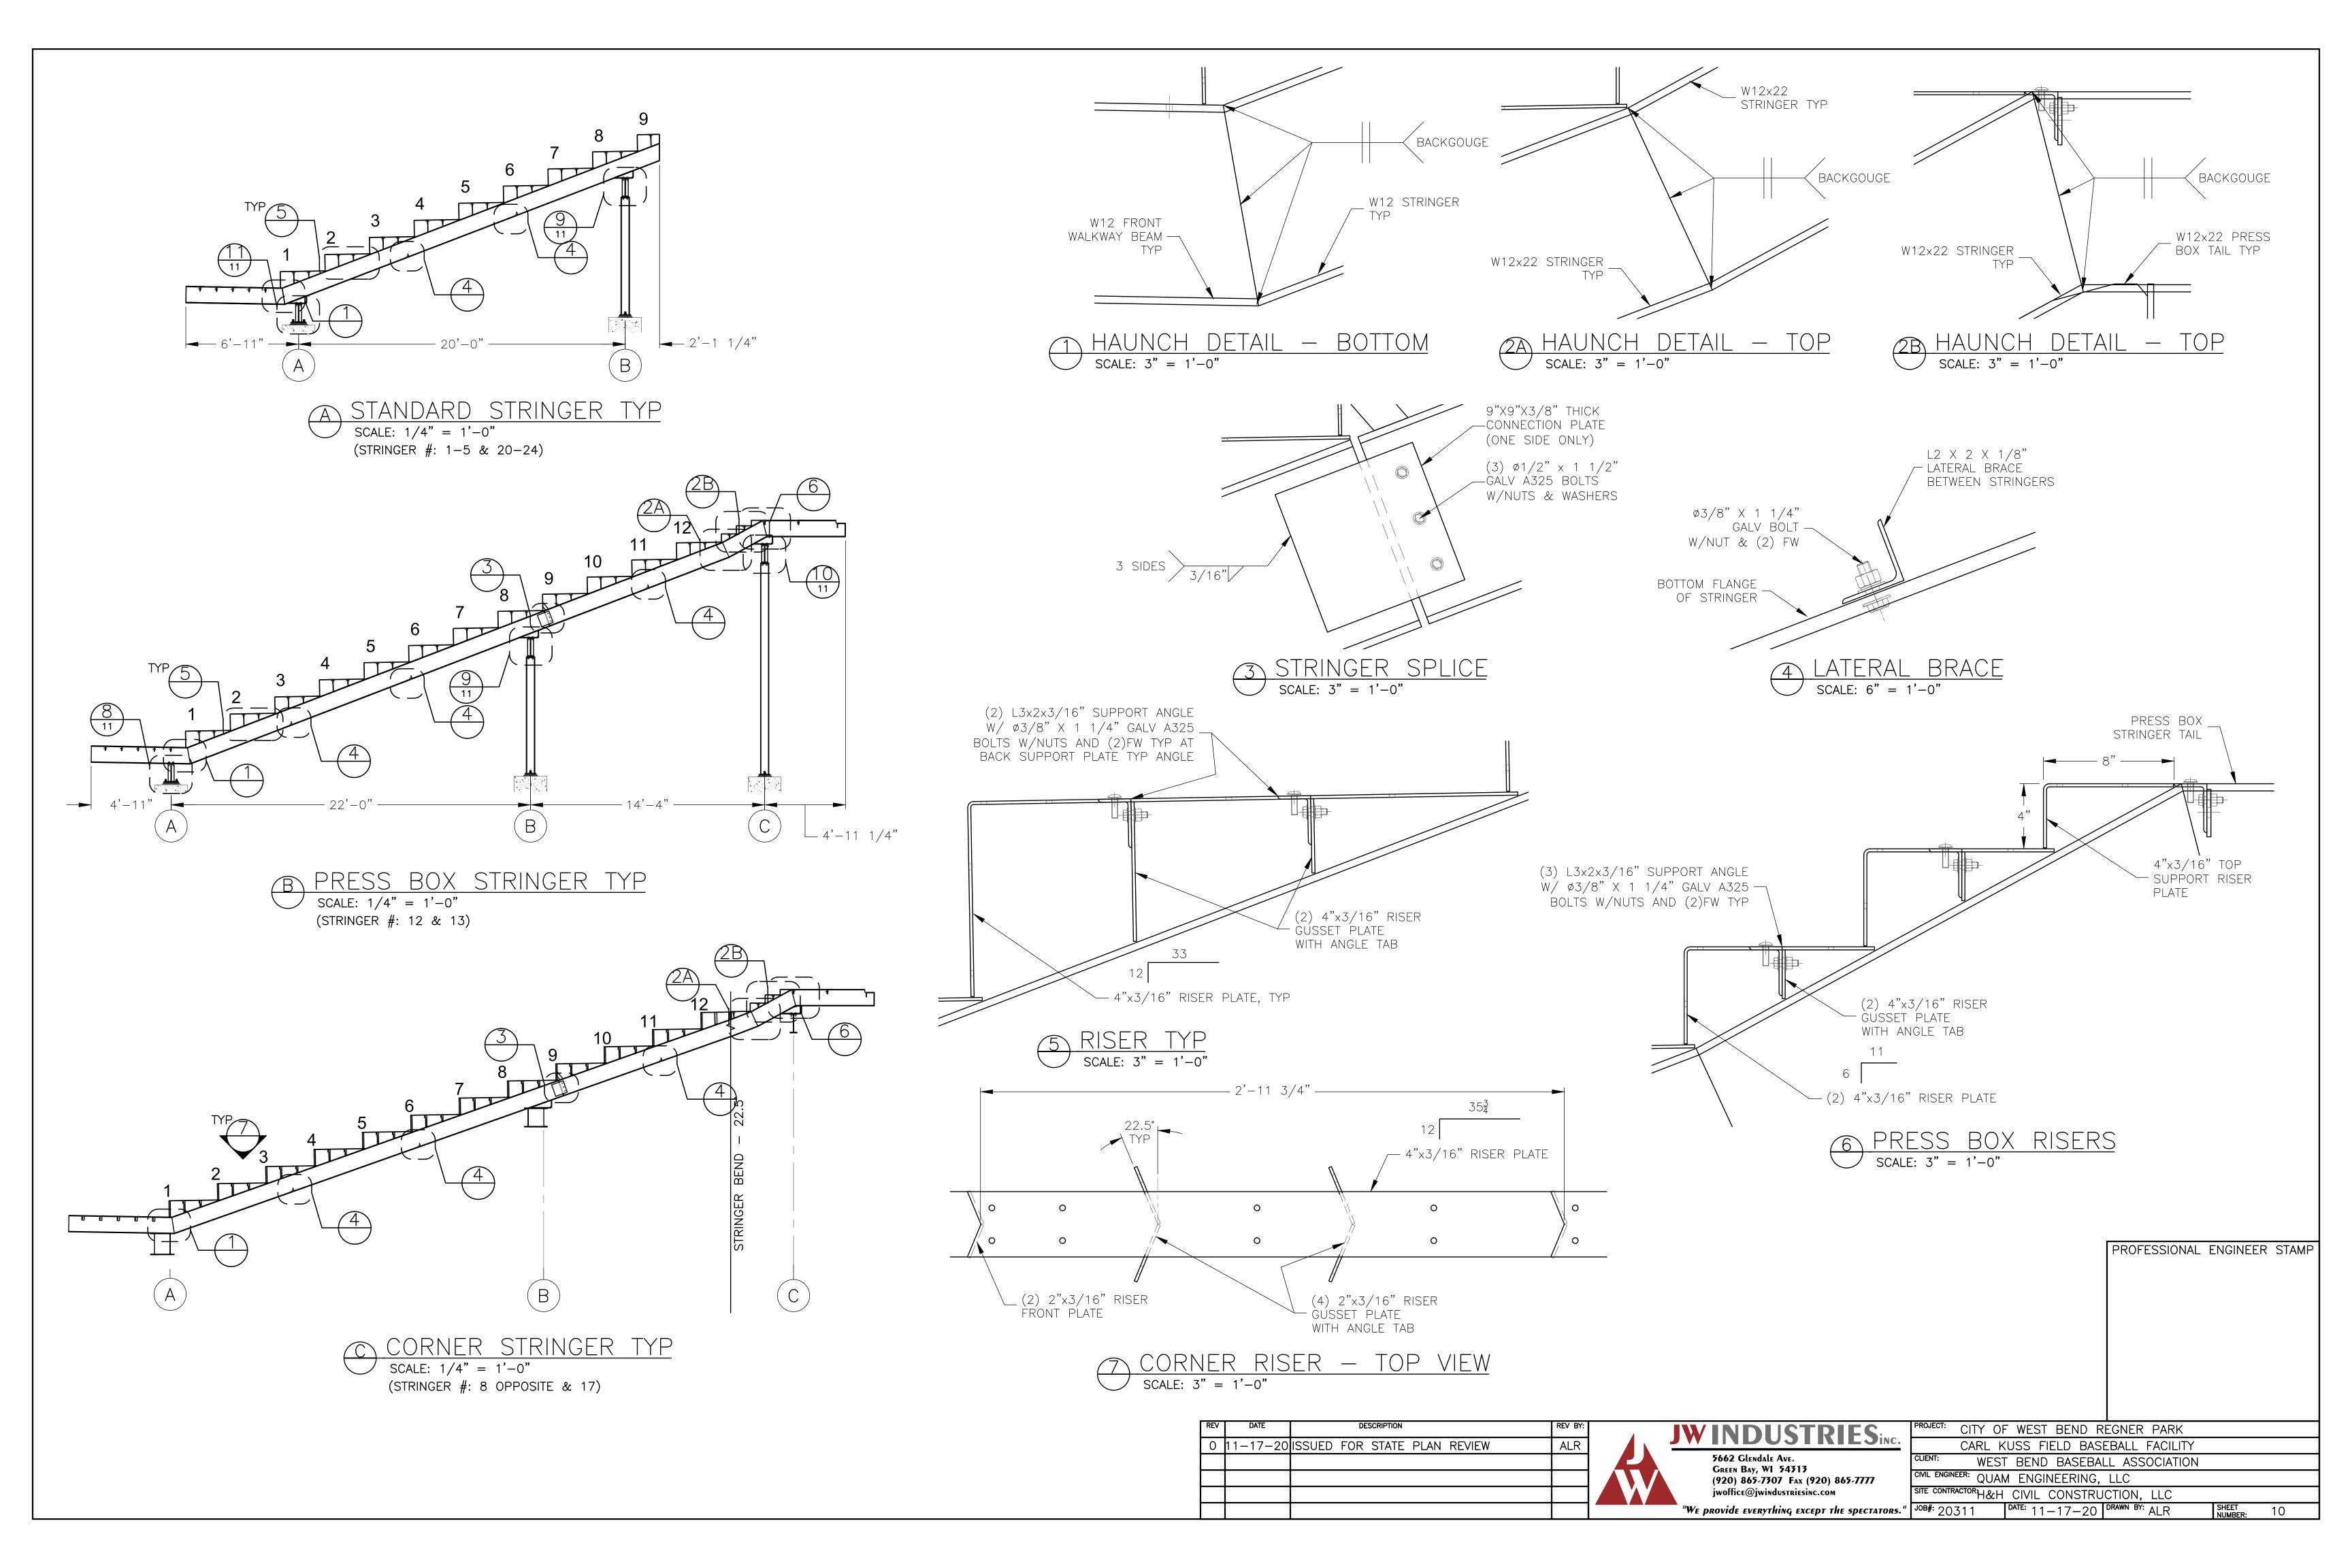


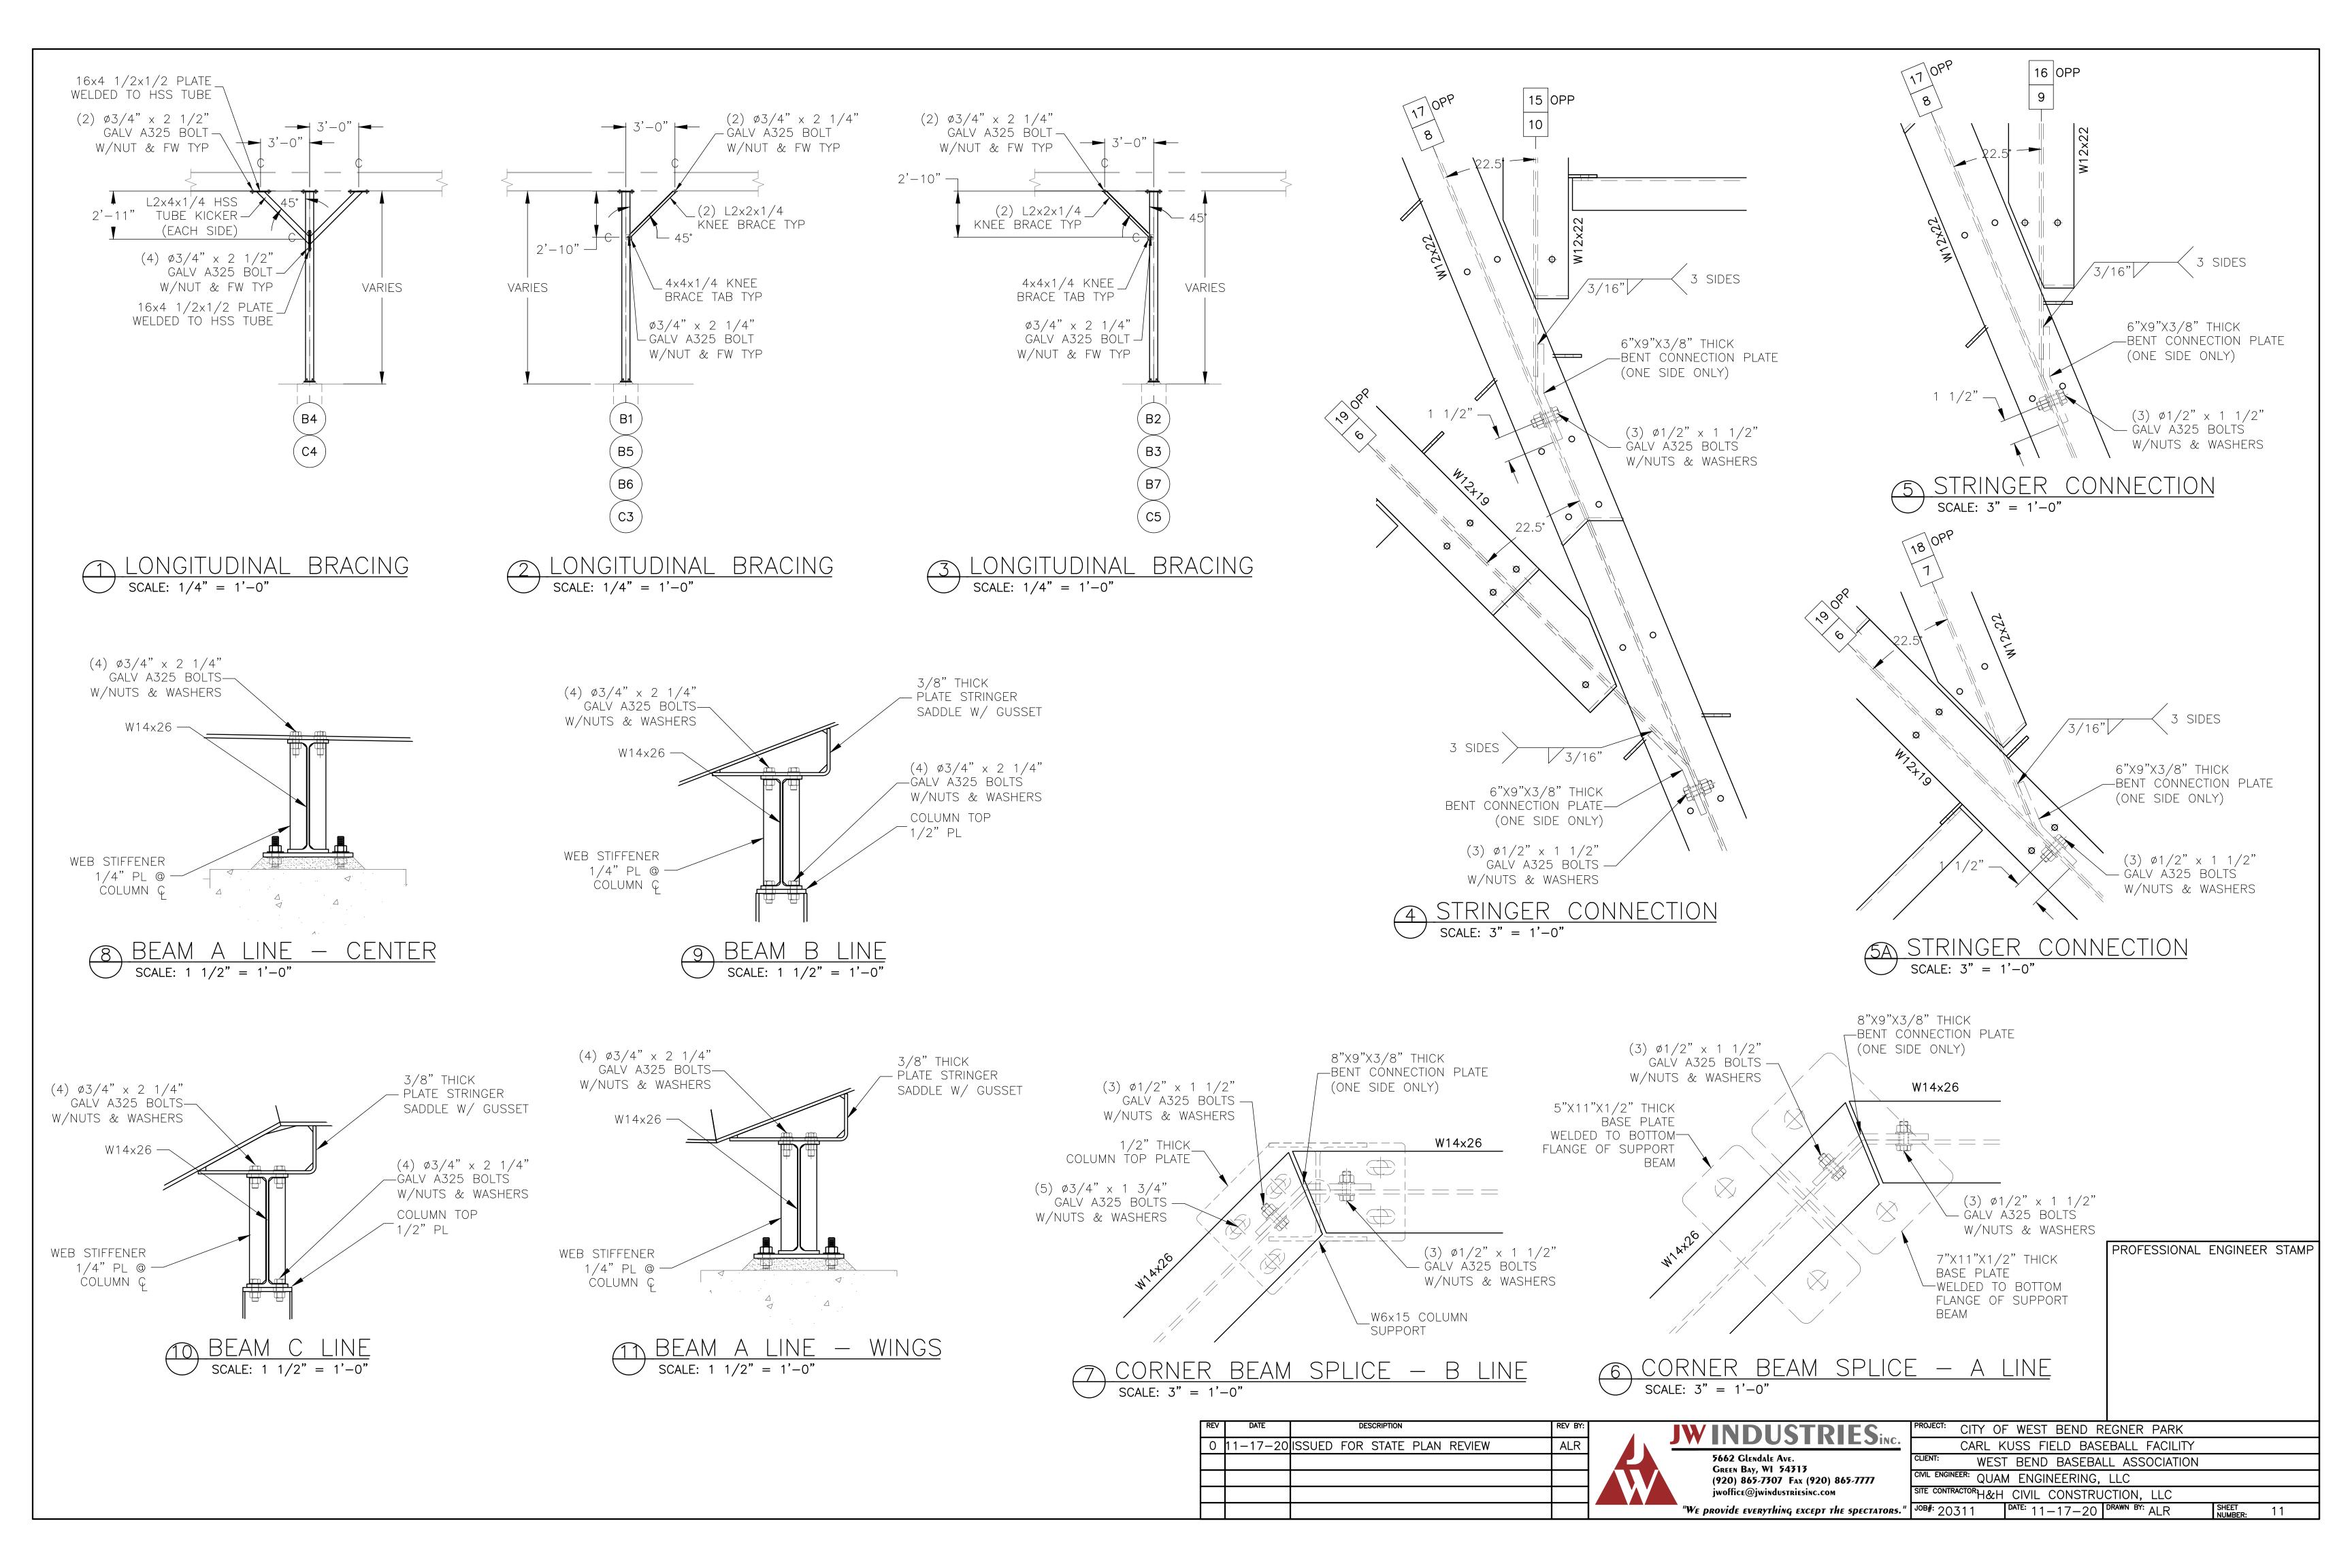


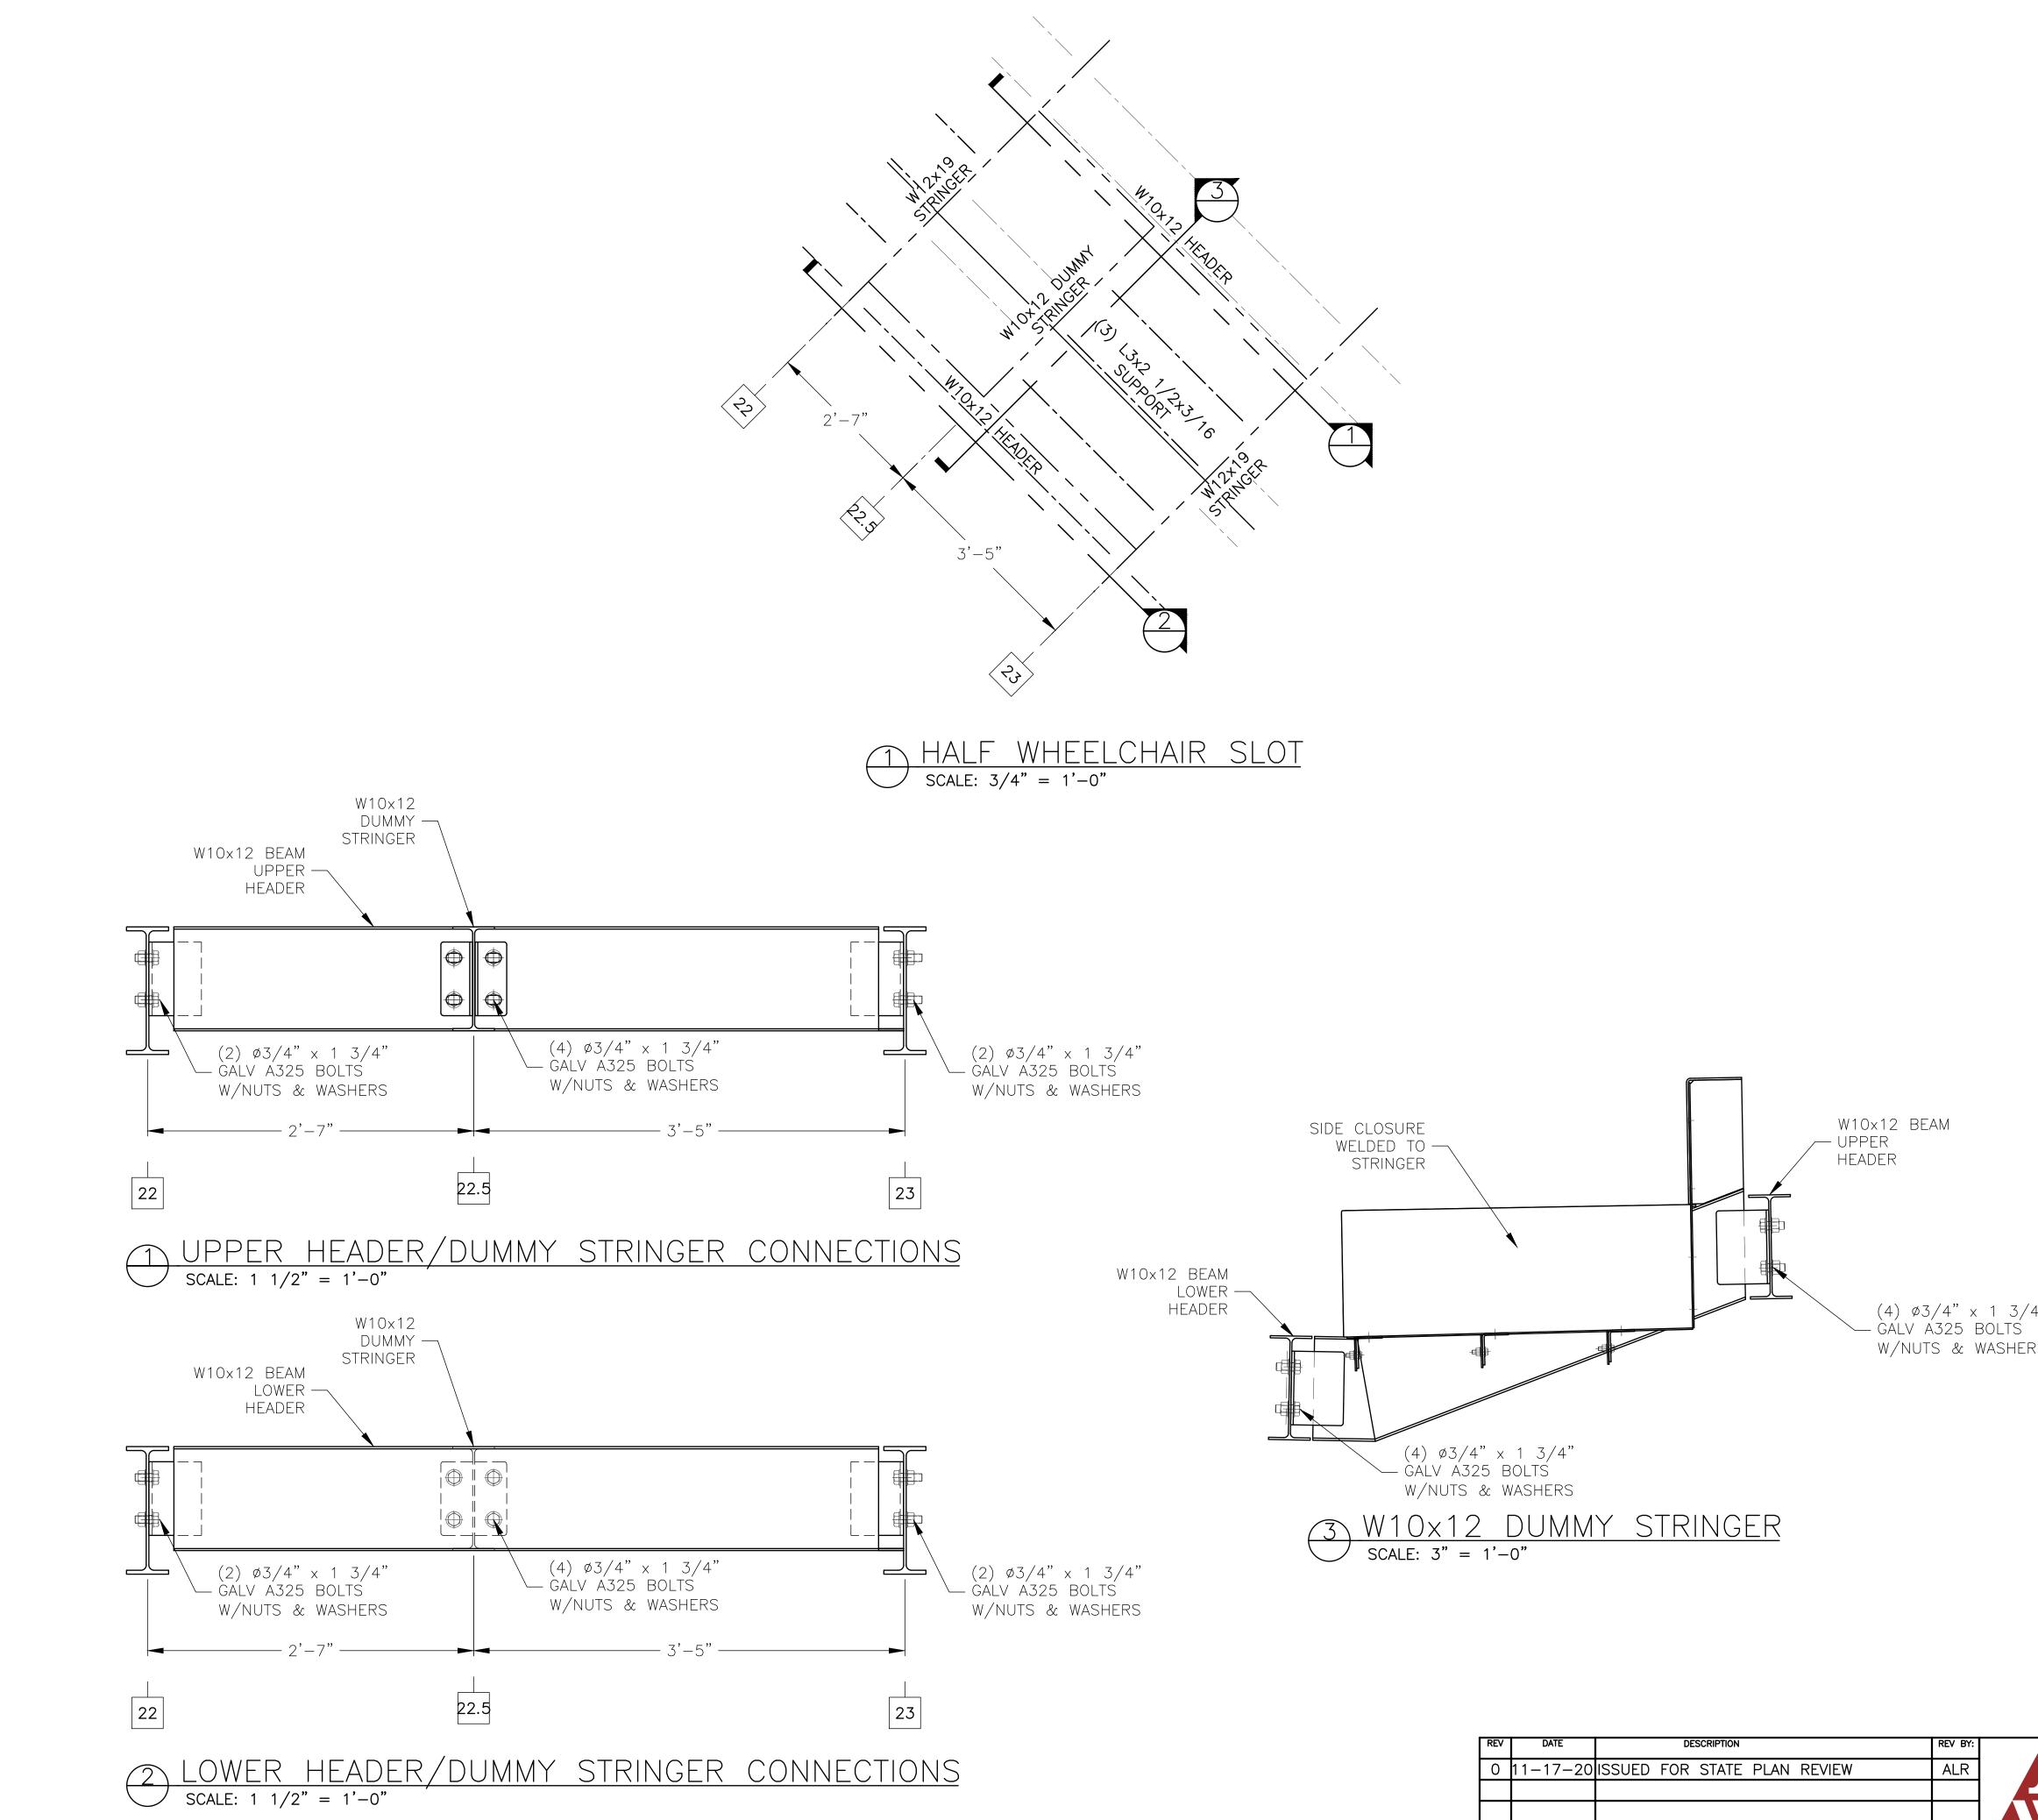


REV	DATE	DESCRIPTION	REV BY:	
0	11-17-20	ISSUED FOR STATE PLAN REVIEW	ALR	
				<b>F</b>


4"									
RS									
						PROF	ESSIONAL	ENGINEER	STAMP
		PROJECT:	CITY 0	F WEST	BEND R	FGNFR	PARK		
	WINDUSIKIESINC.				ELD BASI				
	5662 Glendale Ave.	CLIENT:					OCIATION		
	Green Bay, WI 54313 (920) 865-7307 Fax (920) 865-7777	CIVIL ENGIN	QUA	M ENGIN	IEERING,	LLC			
	jwoffice@jwindustriesinc.com <i>"We provide everything except the spectators."</i>	SITE CONTR	ACTOR H&H		CONSTRU -17-20	CTION, drawn by:	LLC	SHEET NUMBER:	
			<u> </u>	I DATE.		DDAWAL DV.			12

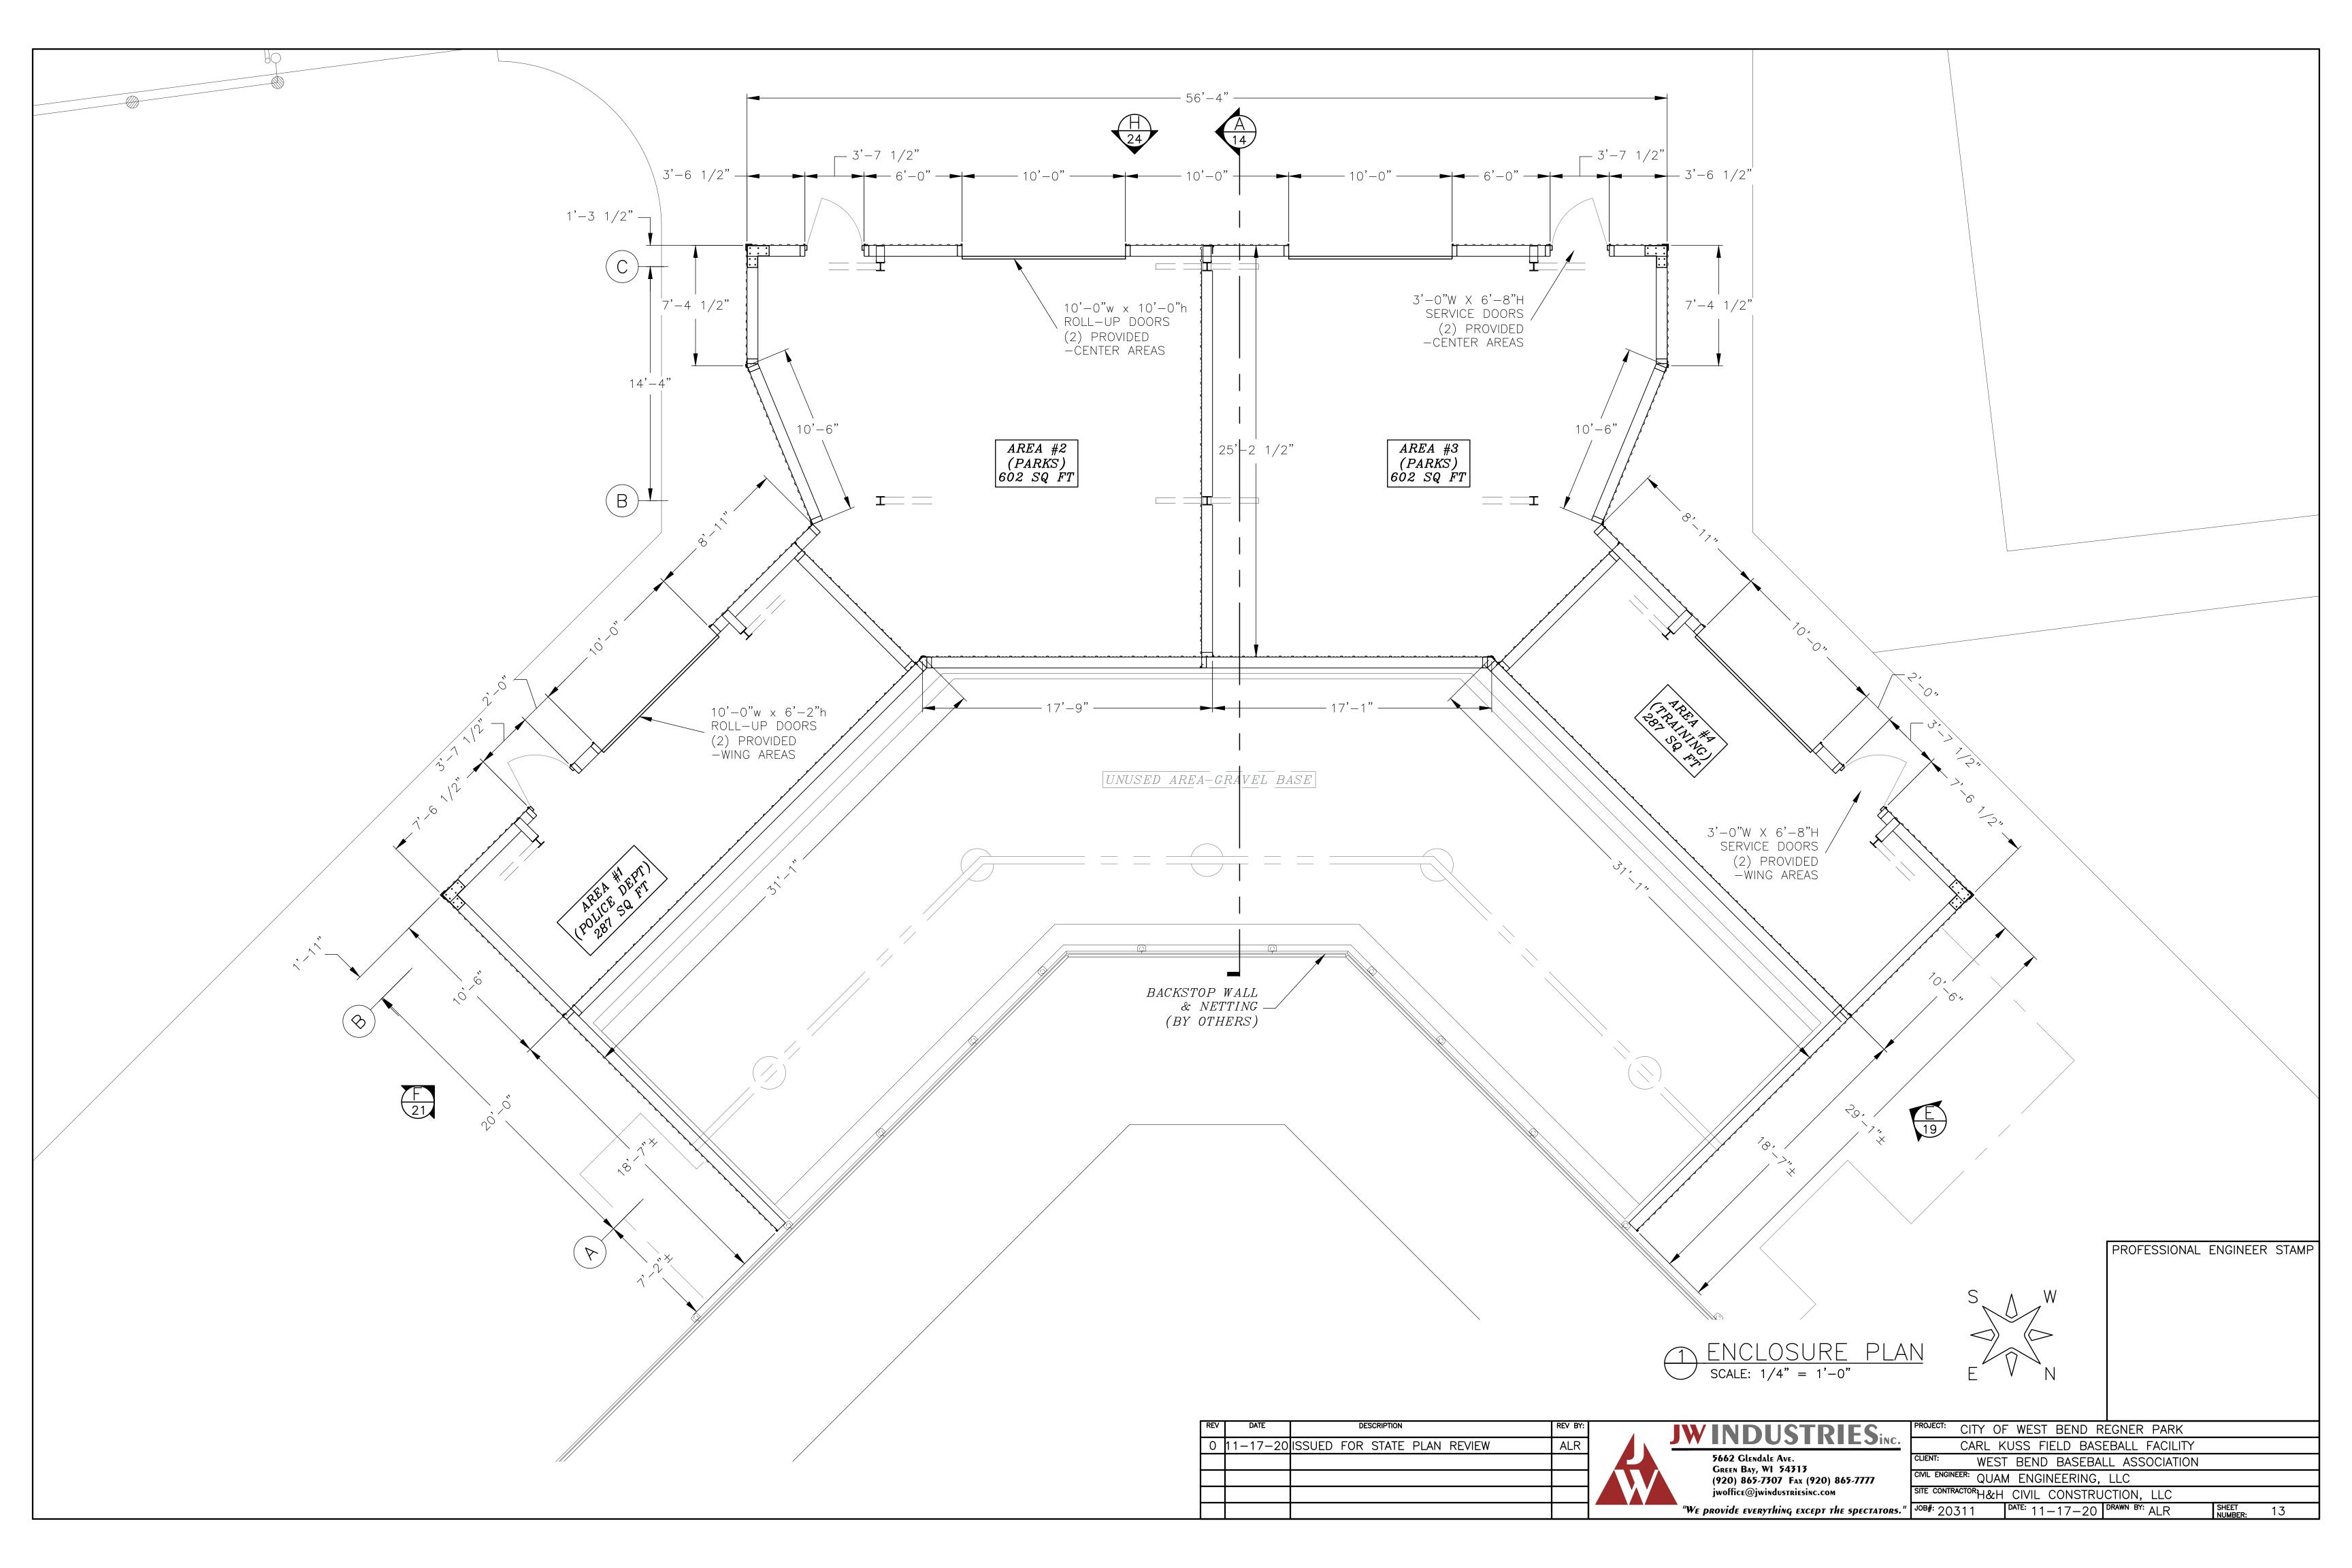

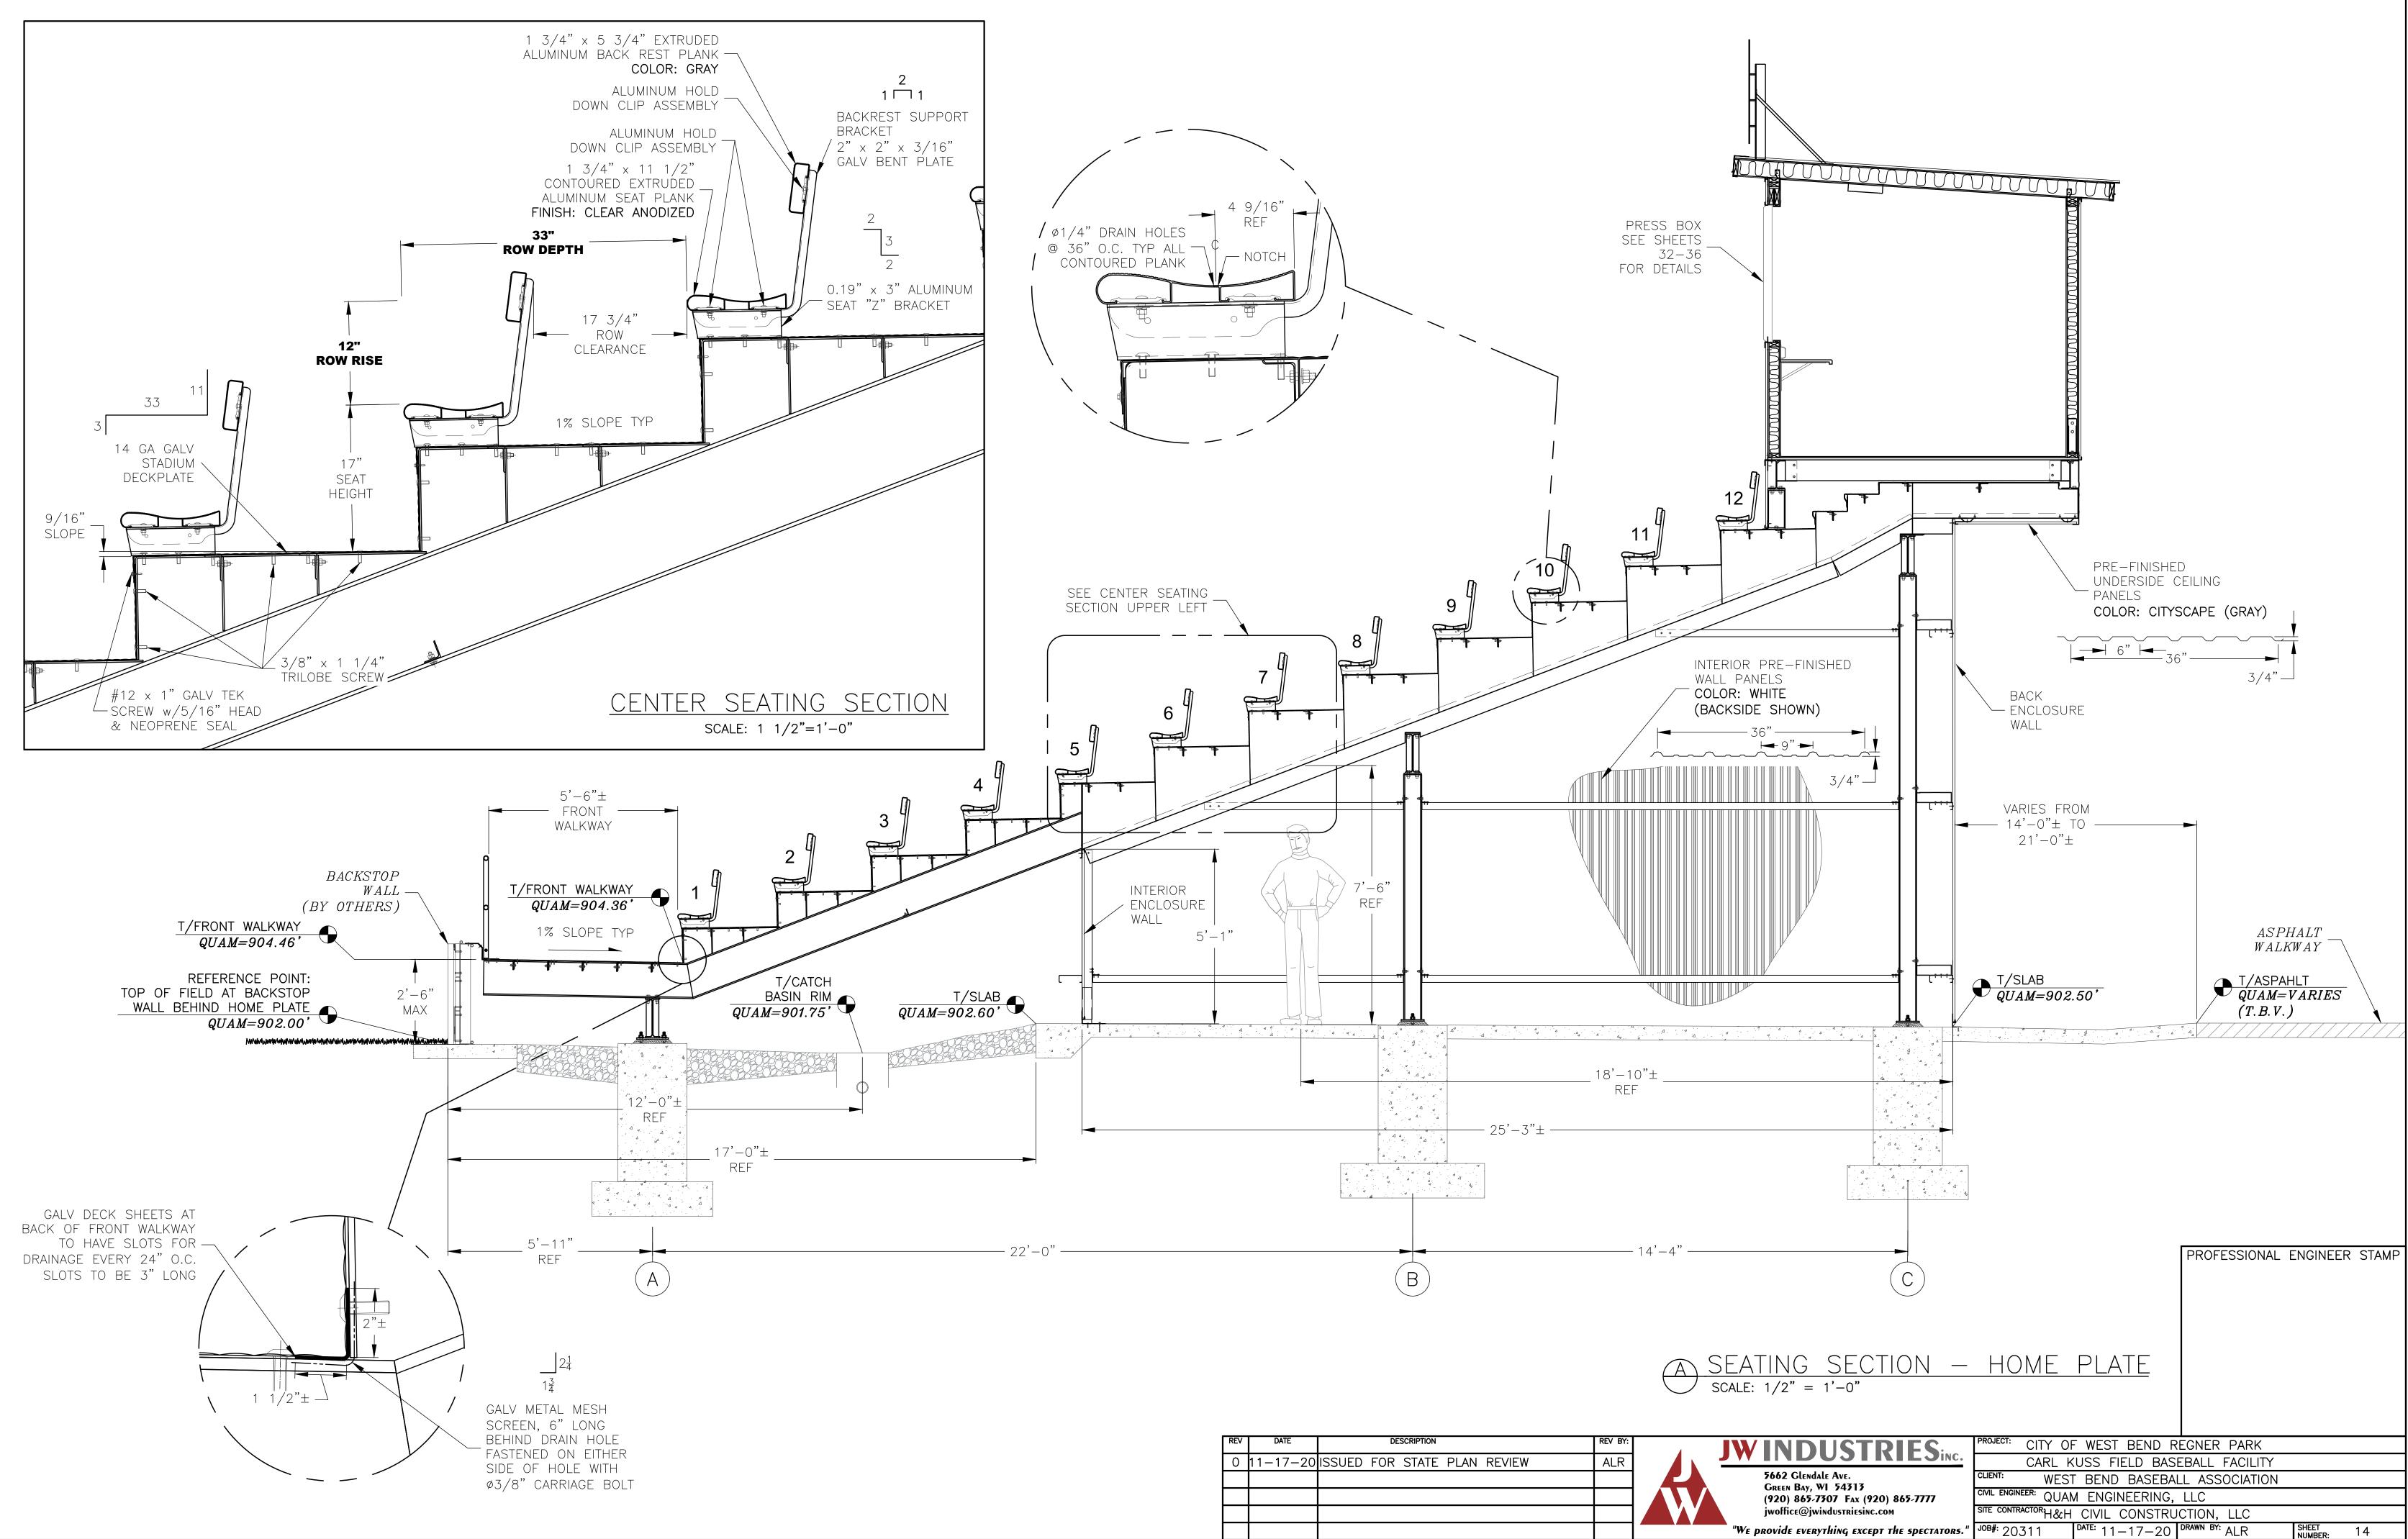


REV	DATE	DESCRIPTION	REV BY:	
0	11-17-20	ISSUED FOR STATE PLAN REVIEW	ALR	

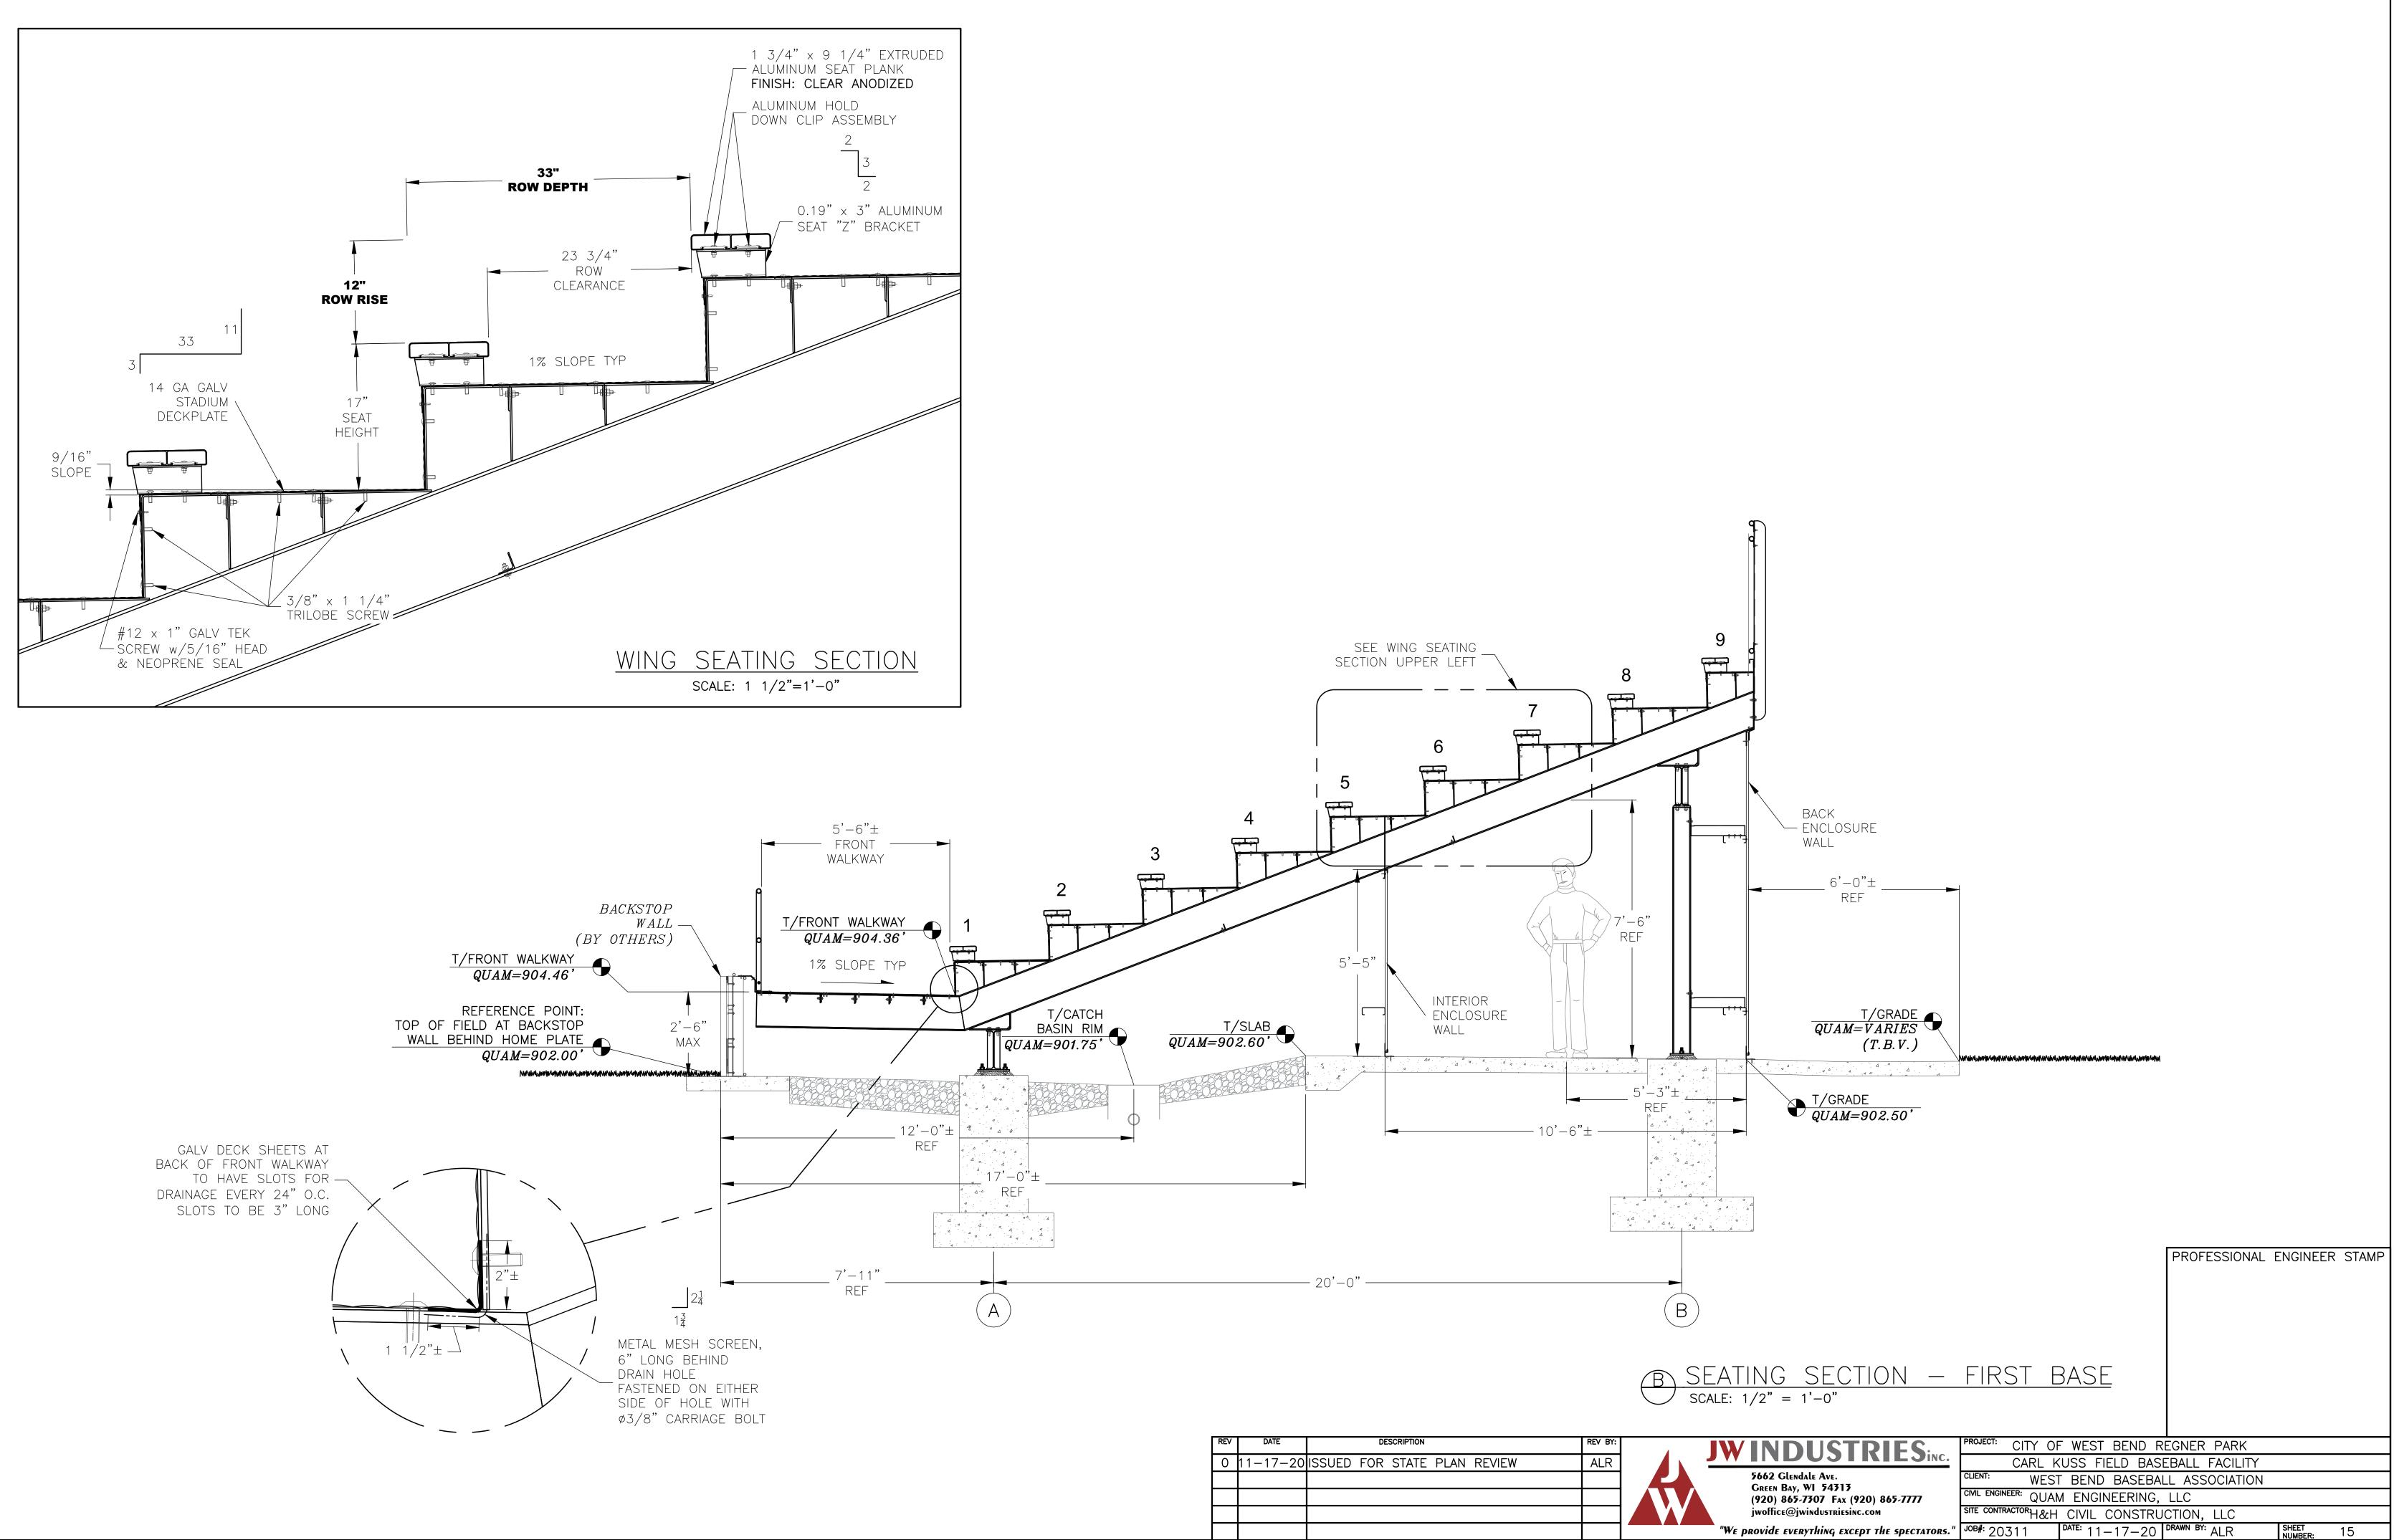


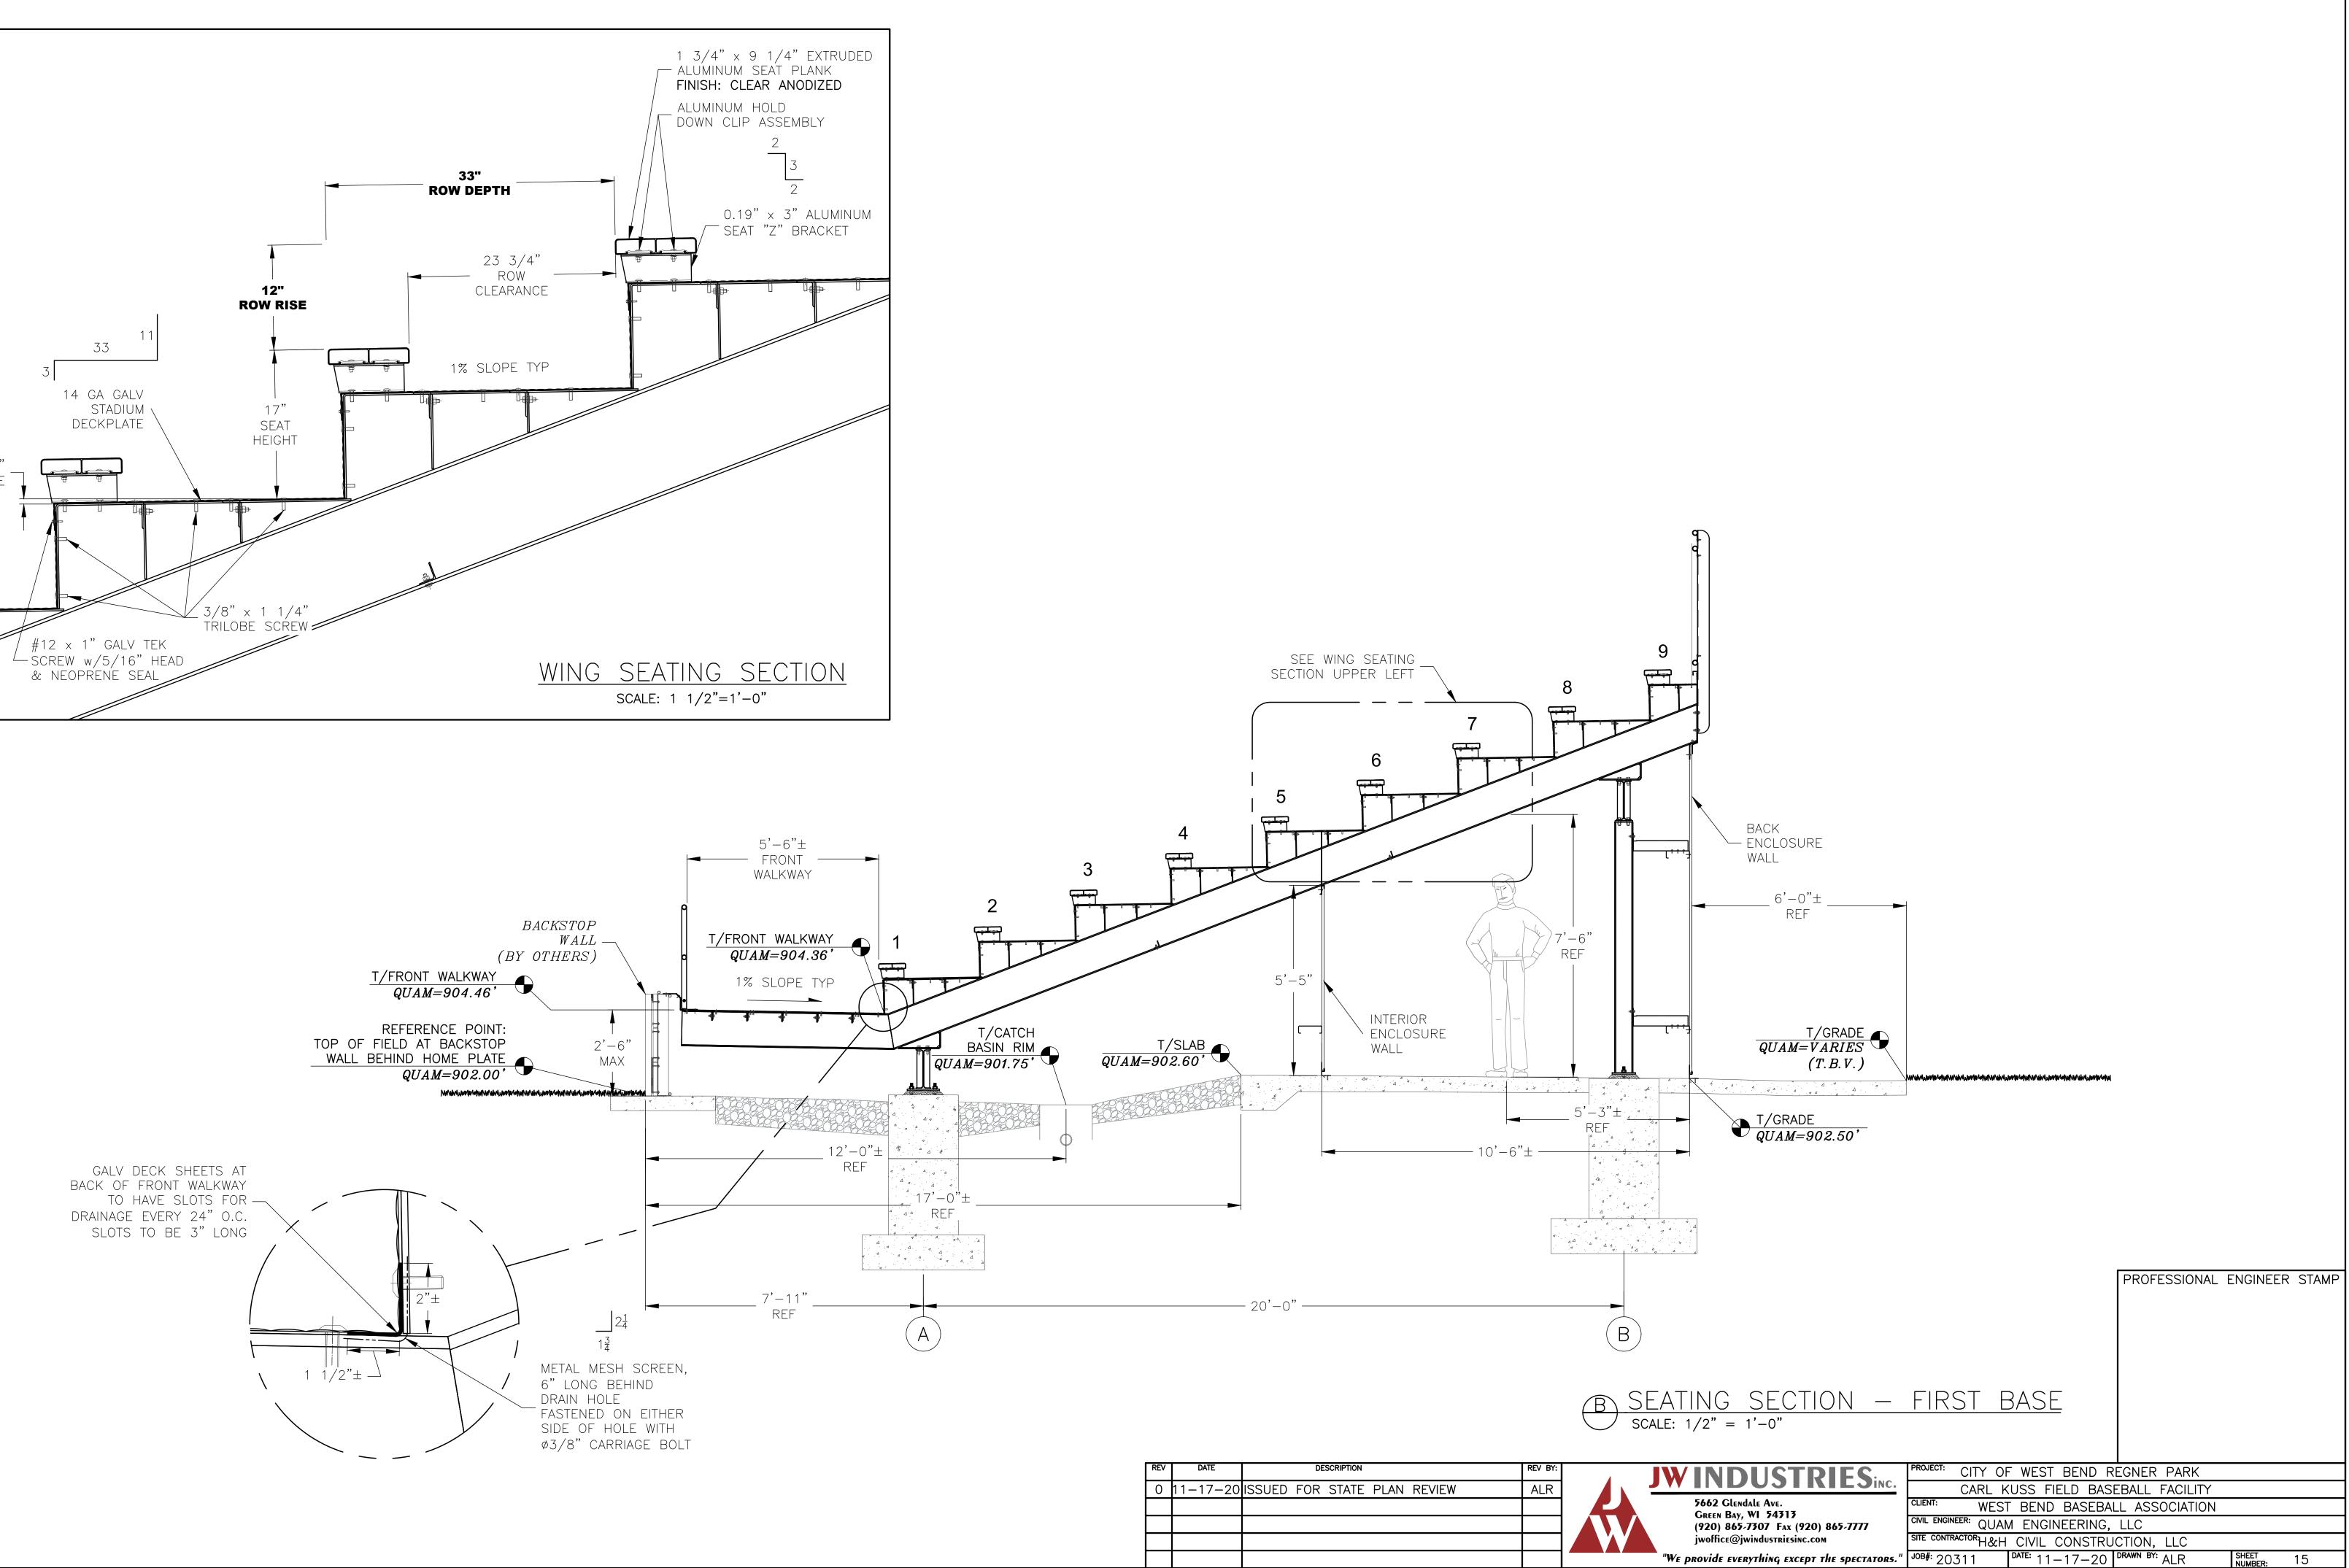


REV	DATE	DESCRIPTION	REV BY:	
0	11-17-20	ISSUED FOR STATE PLAN REVIEW	ALR	

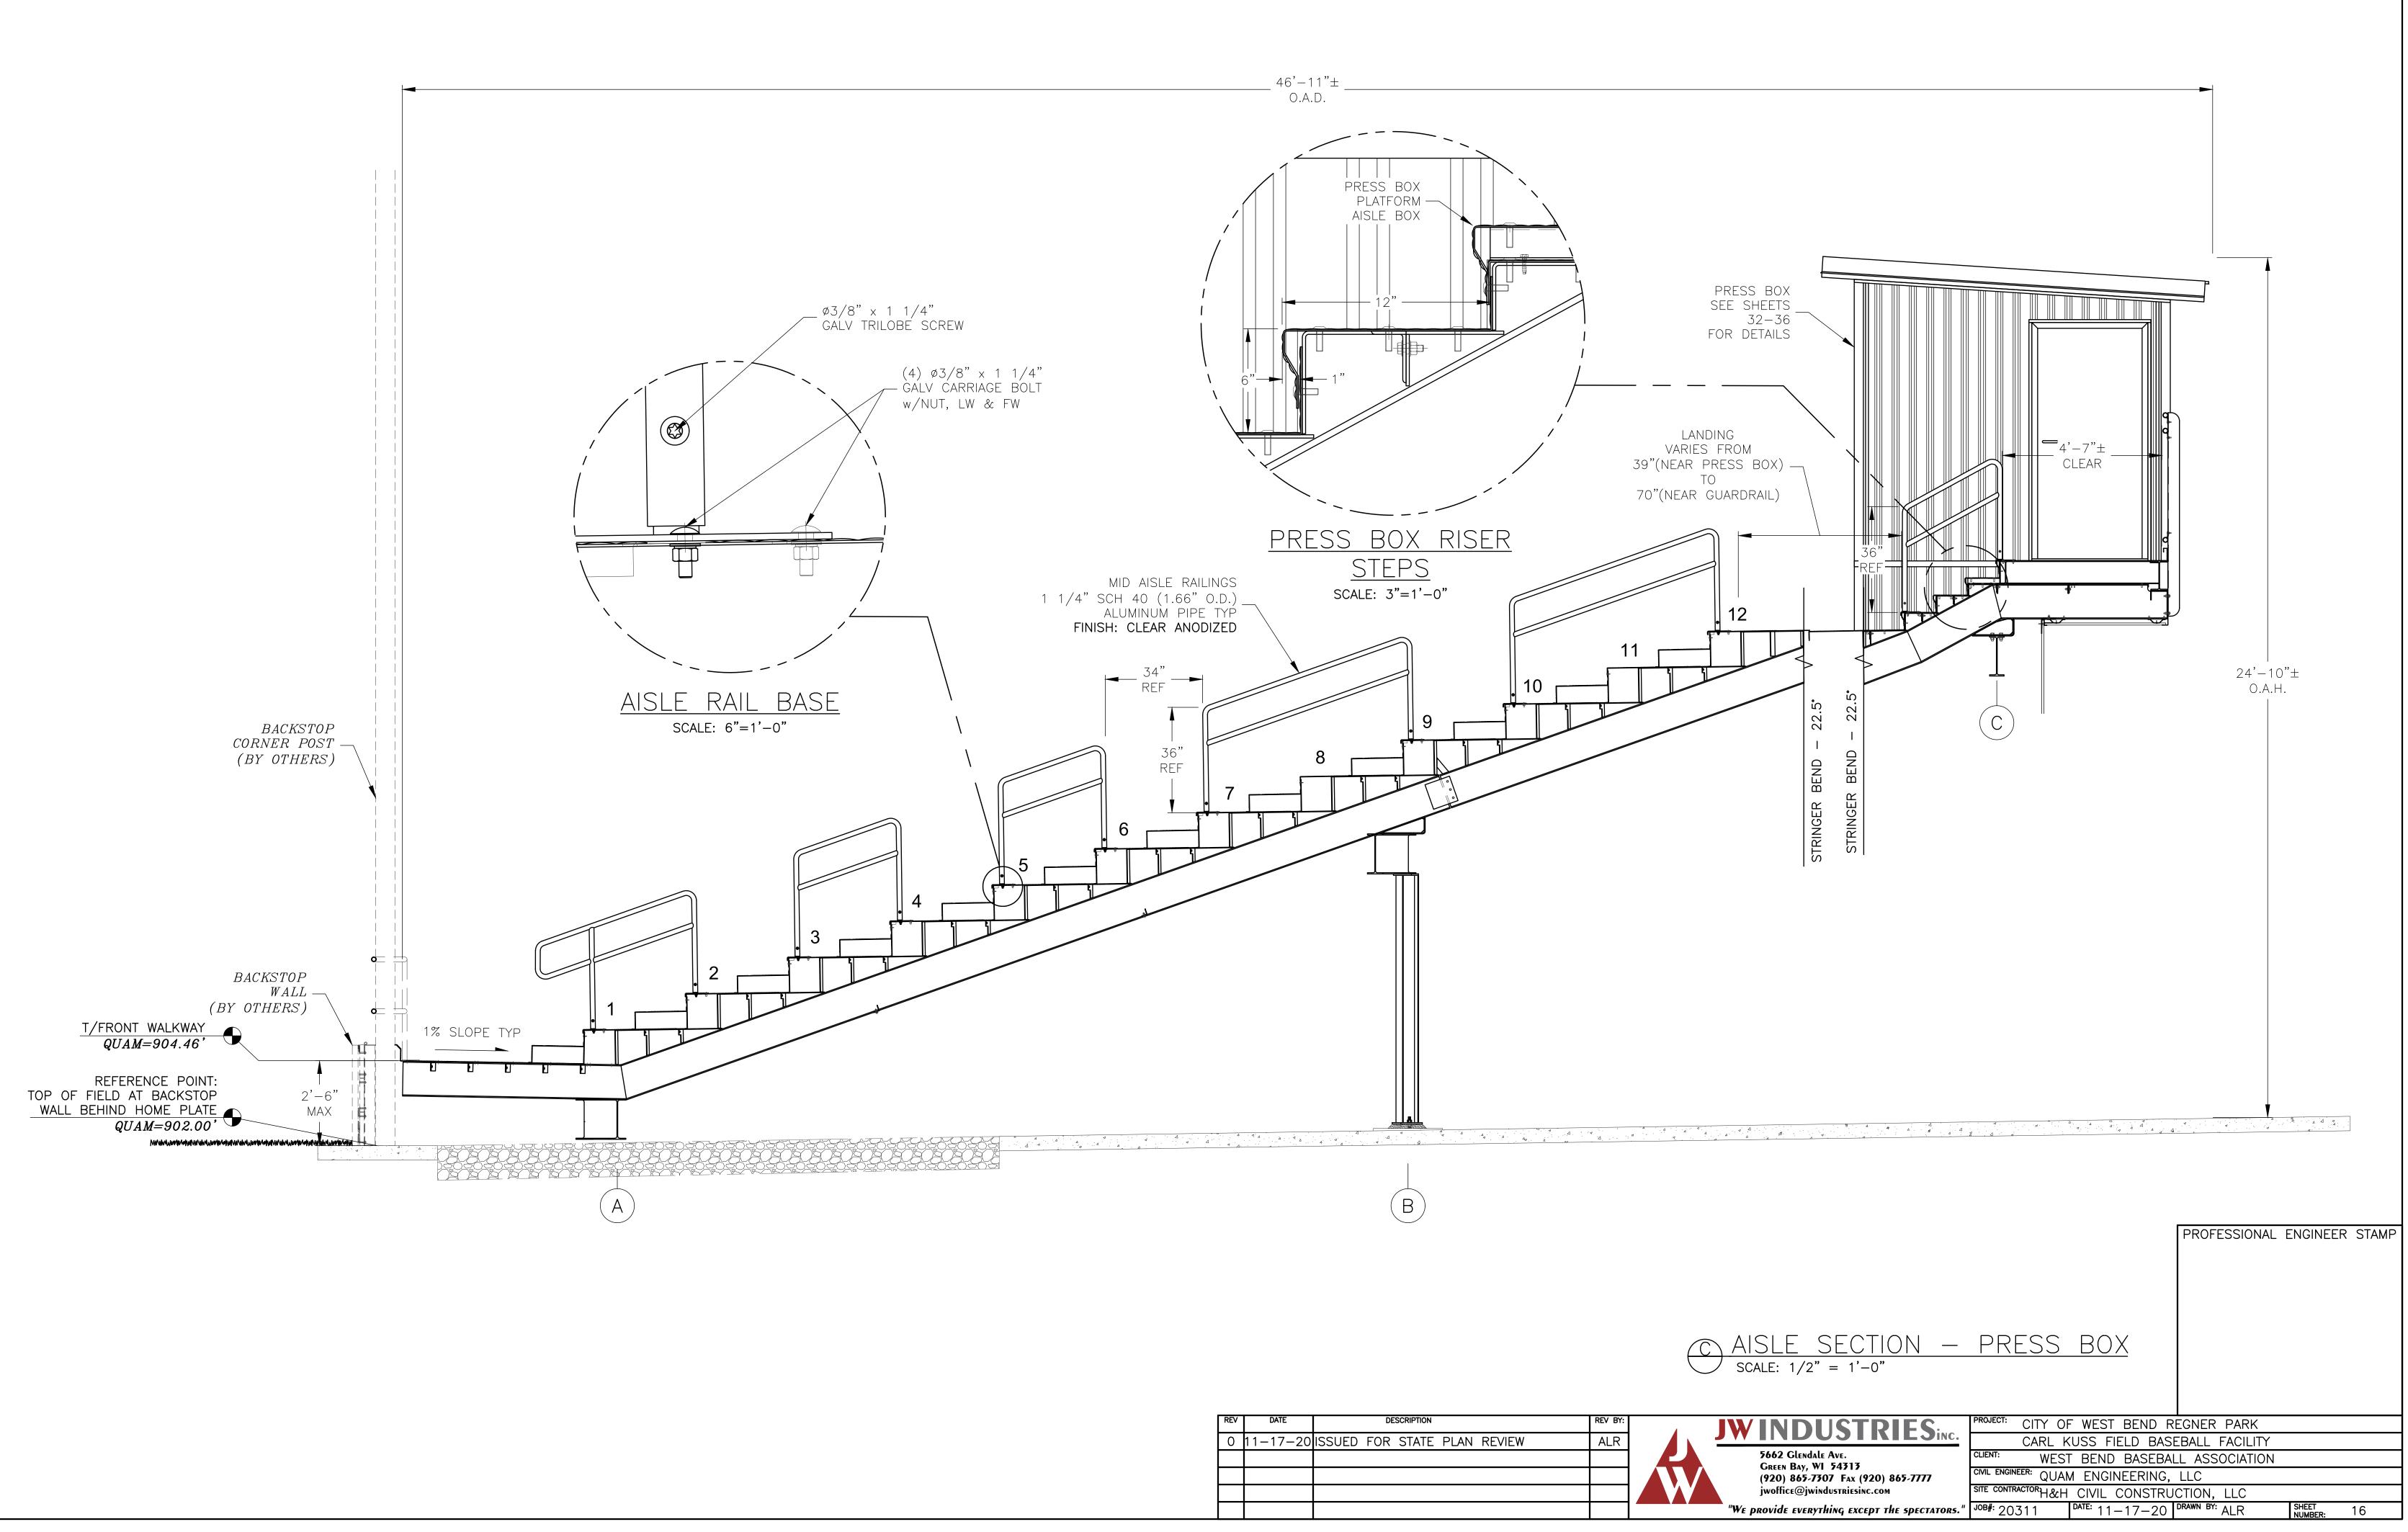


REV	DATE	DESCRIPTION		REV BY:	
0	11-17-20	SSUED FOR STATE PLAN	REVIEW	ALR	

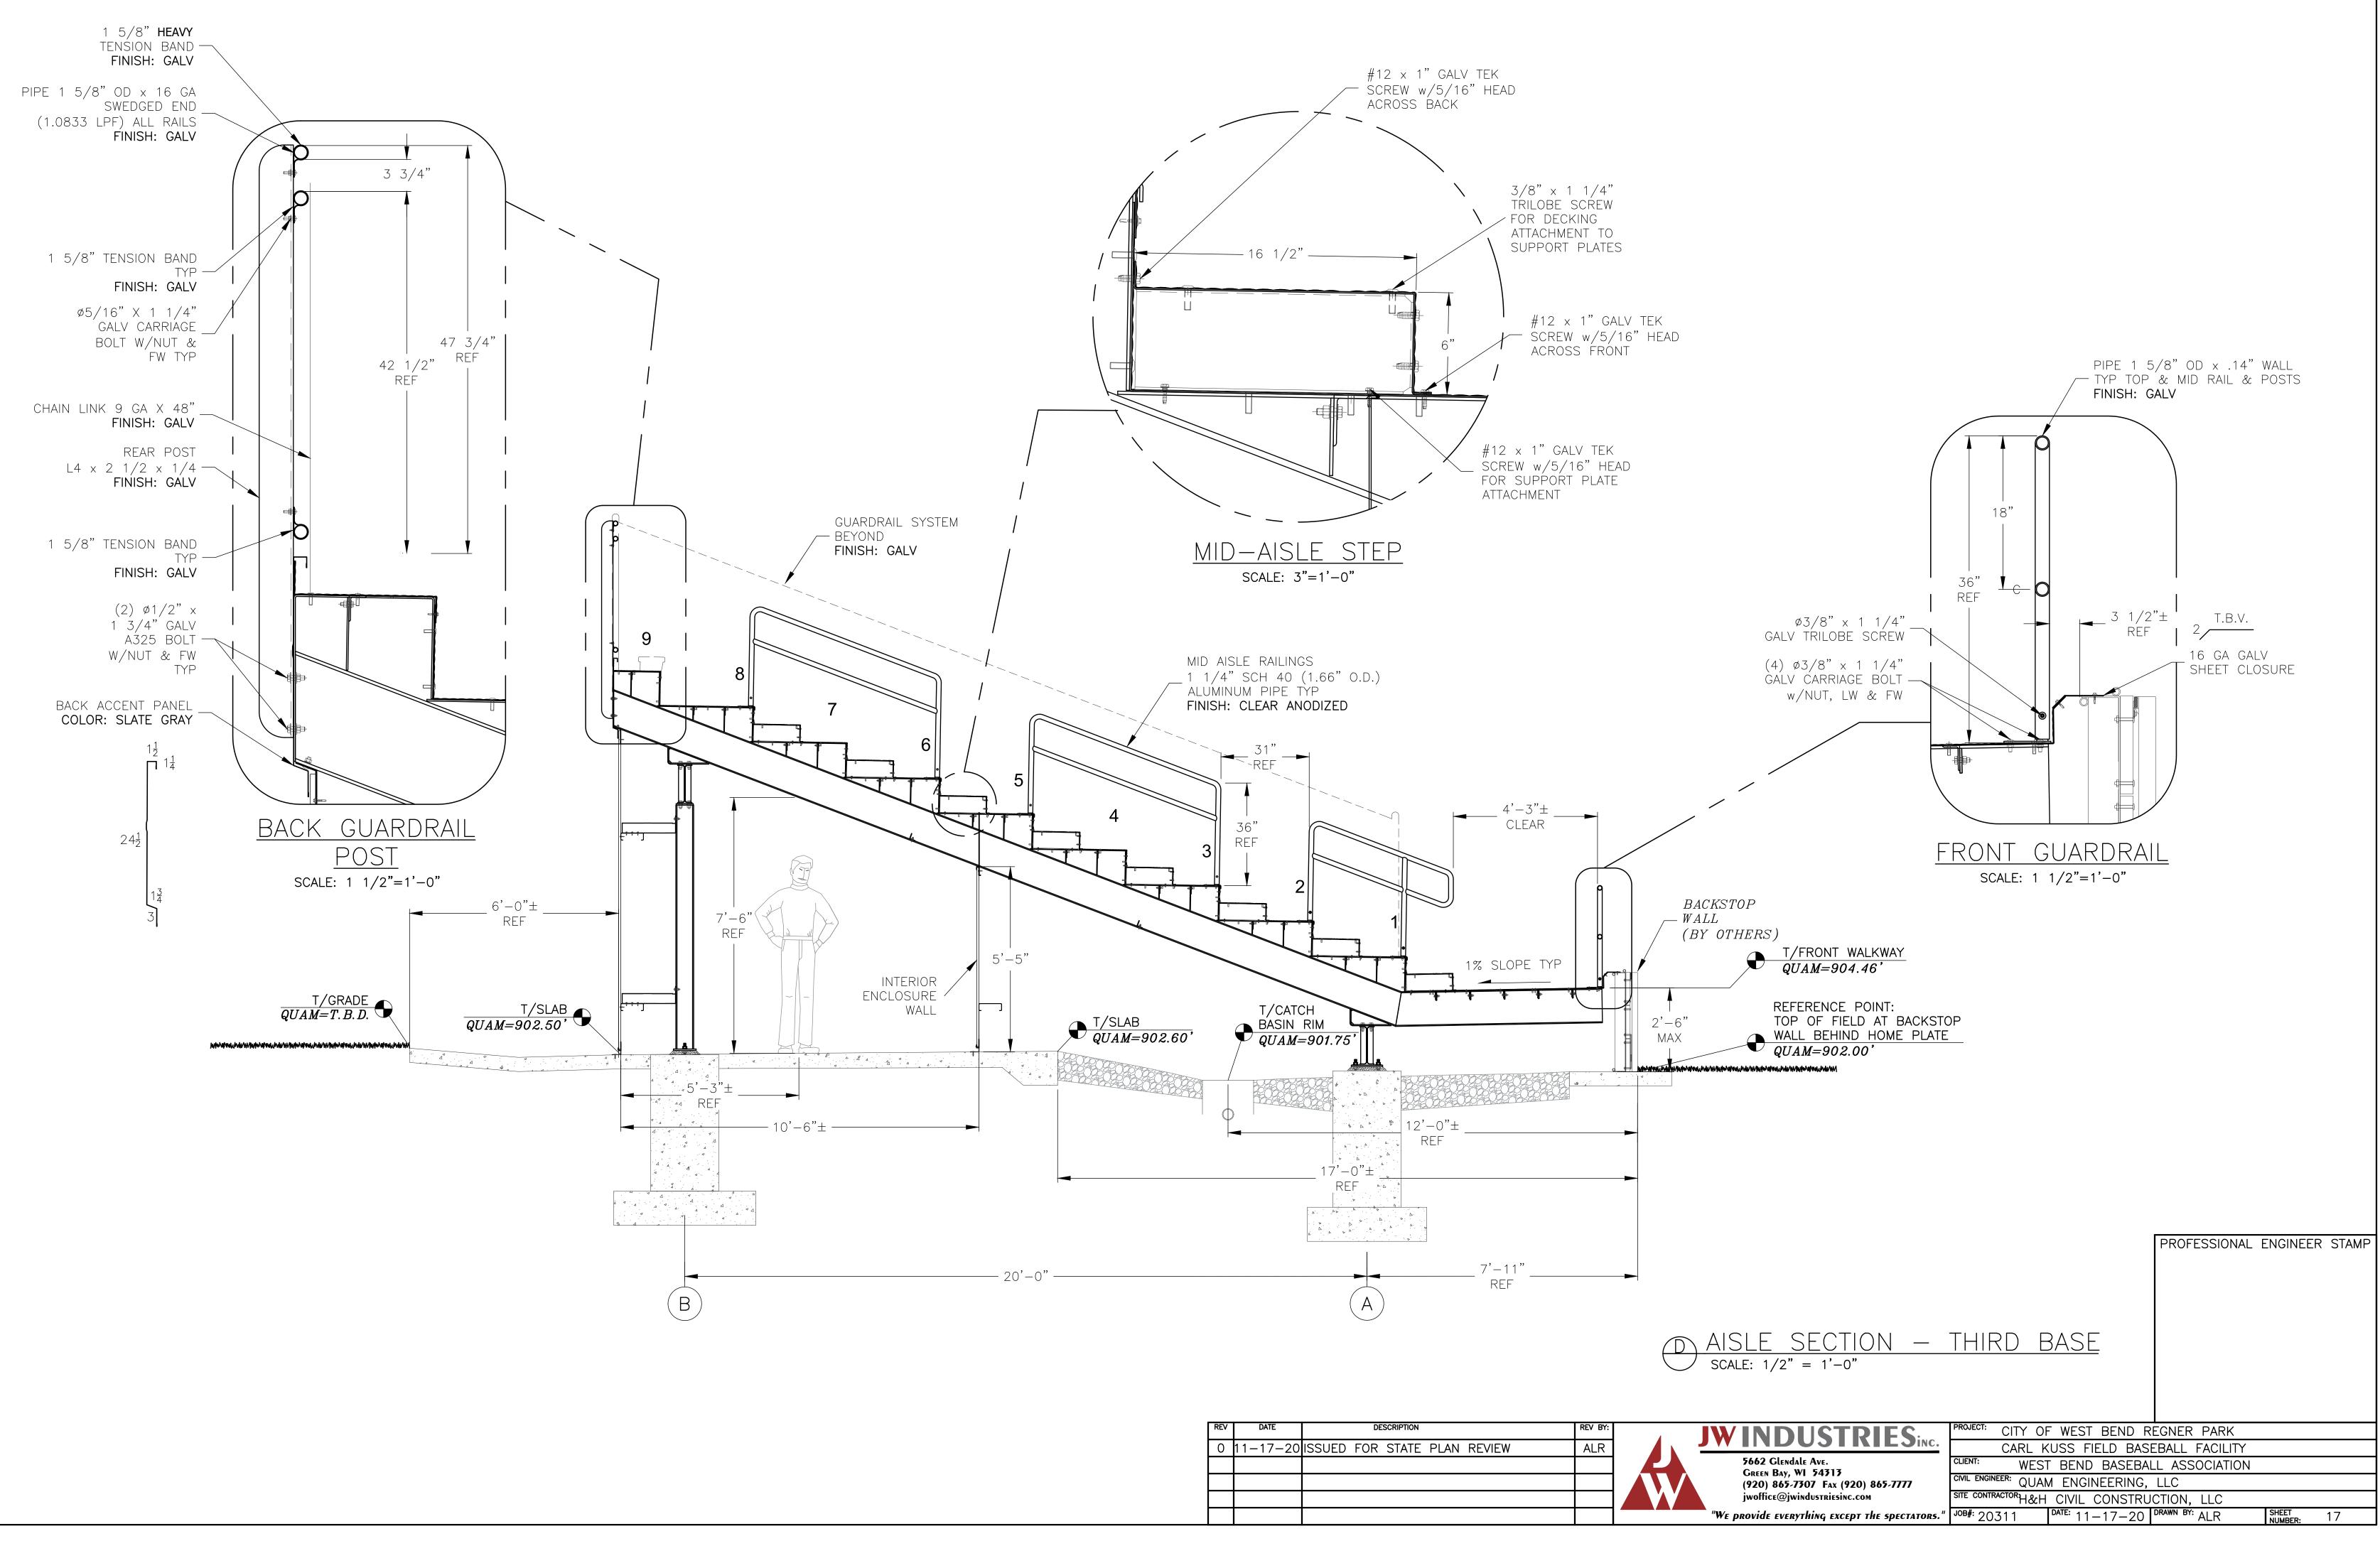


0 11–17–20 ISSUED FOR STATE PLAN REVIEW ALR	4
	4

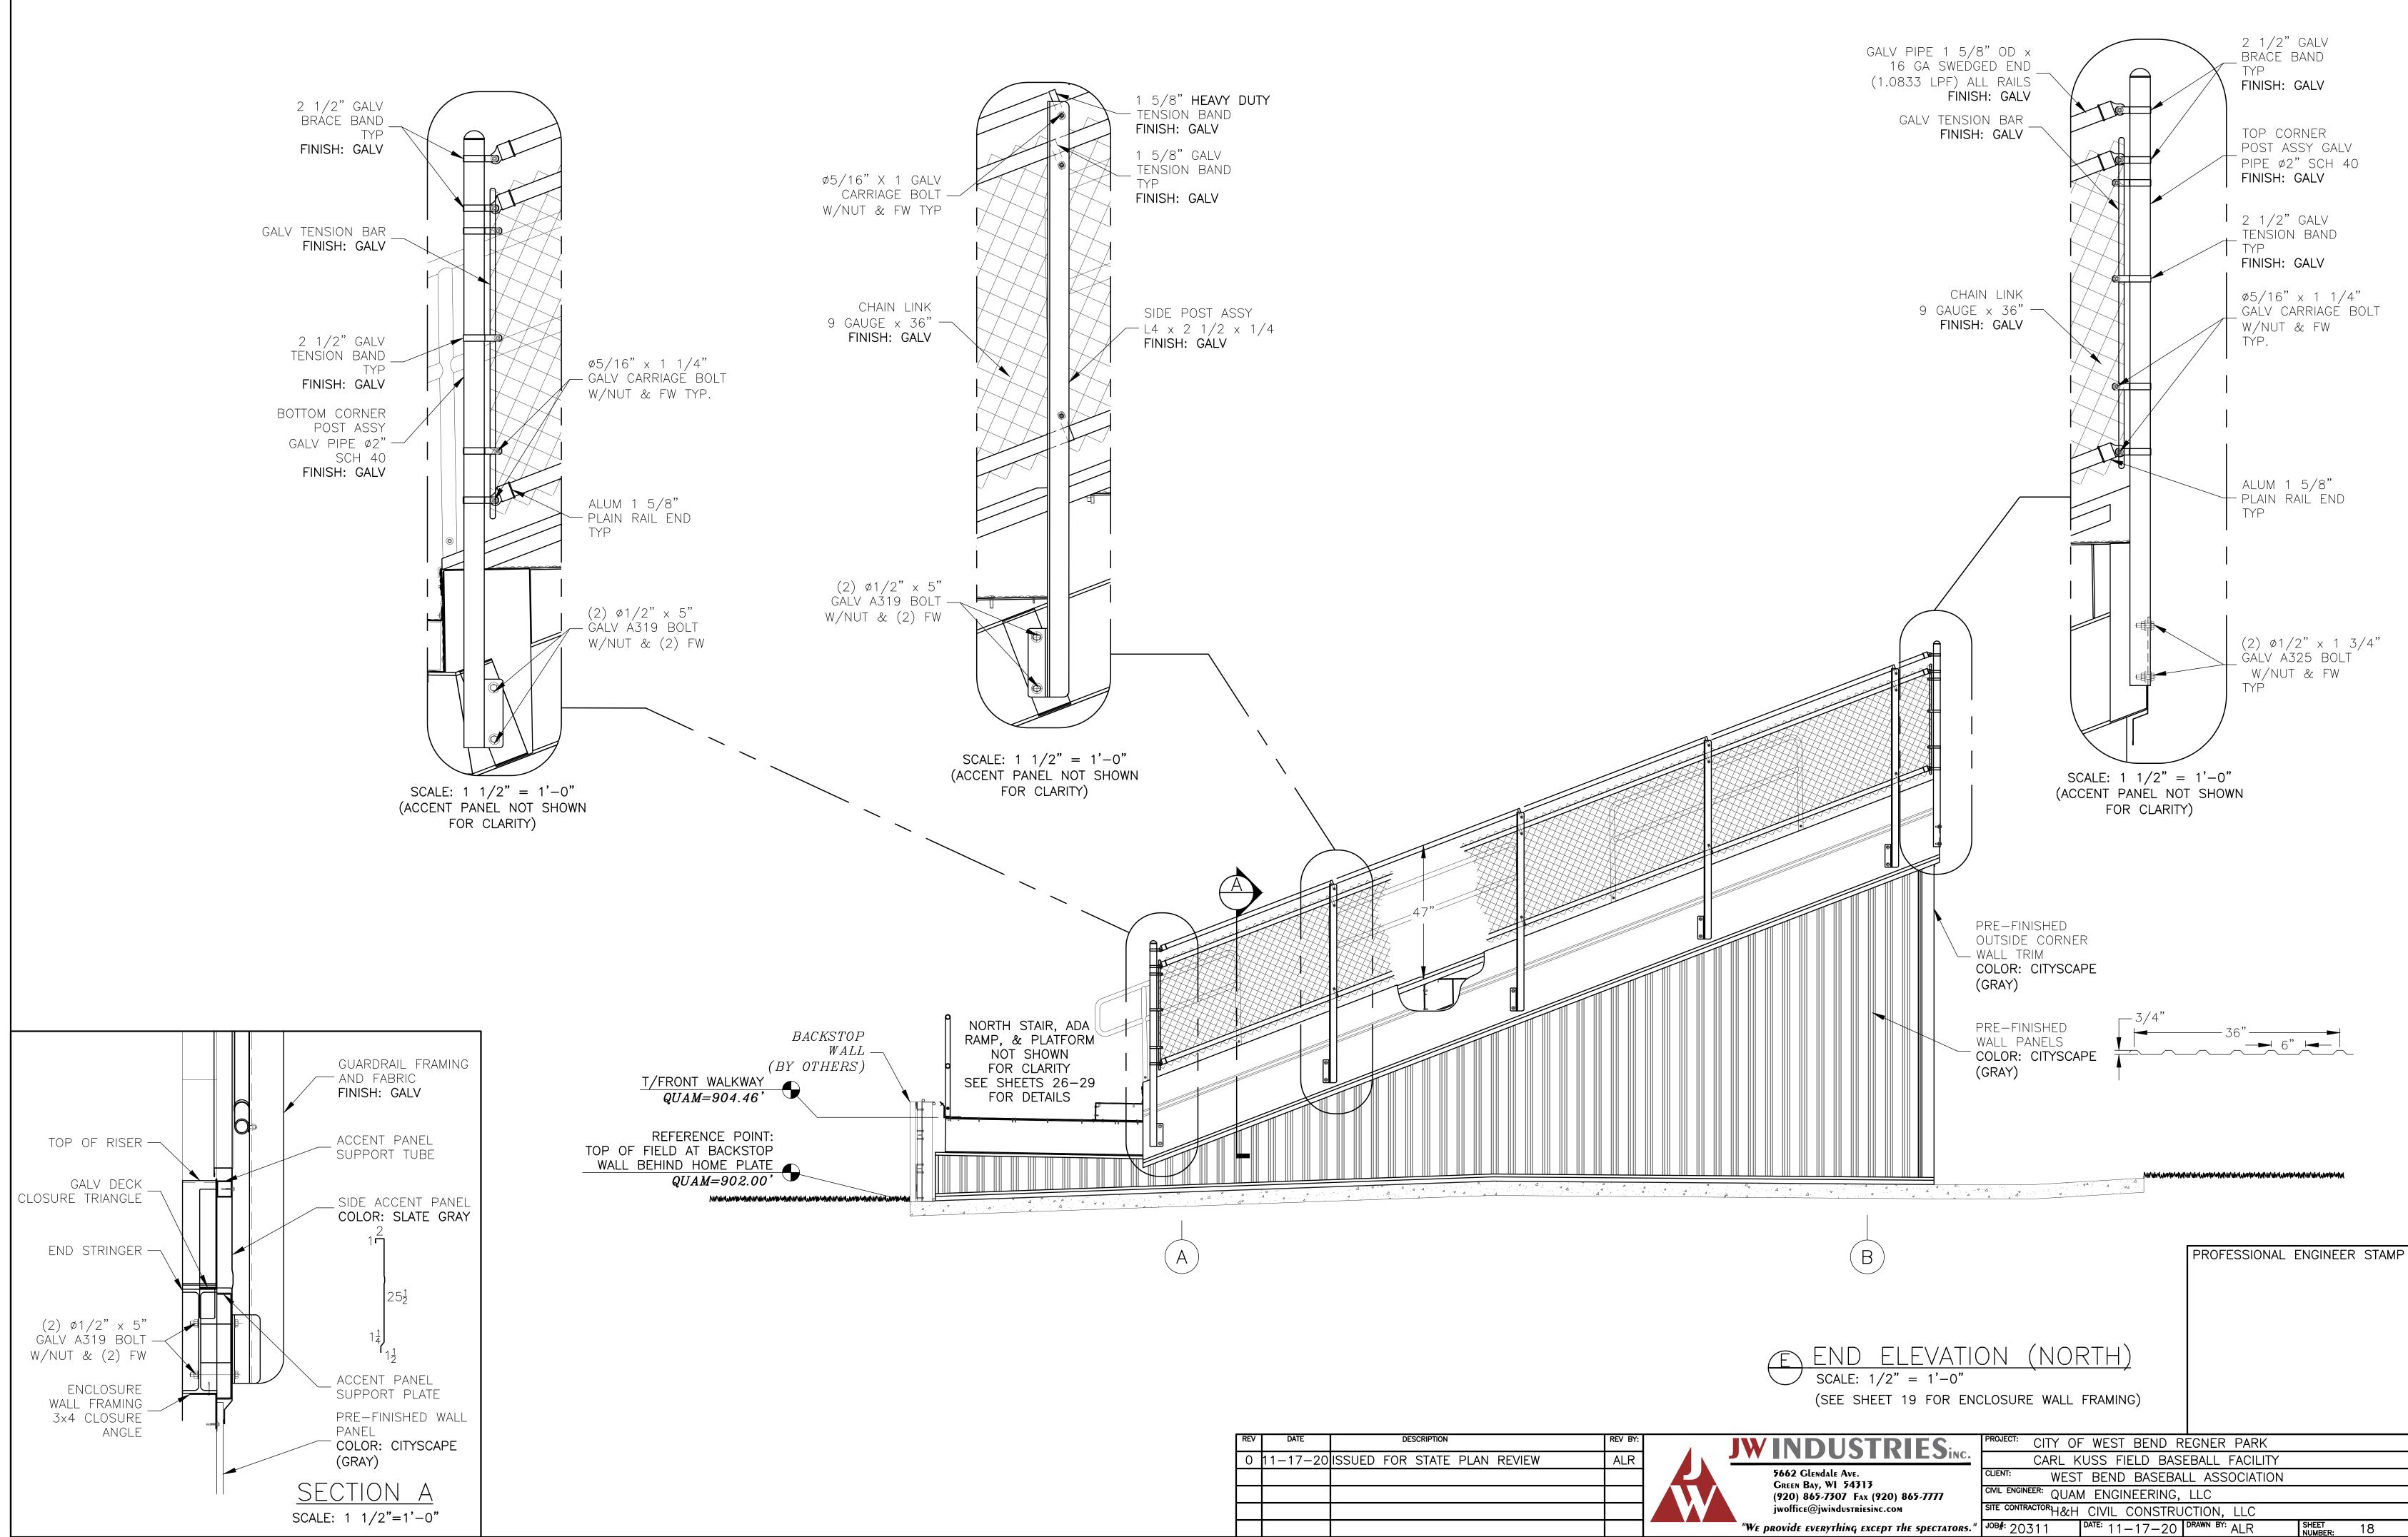


REV	DATE	DESCRIPTION	REV BY:	
0	11-17-20	ISSUED FOR STATE PLAN REVIEW	ALR	

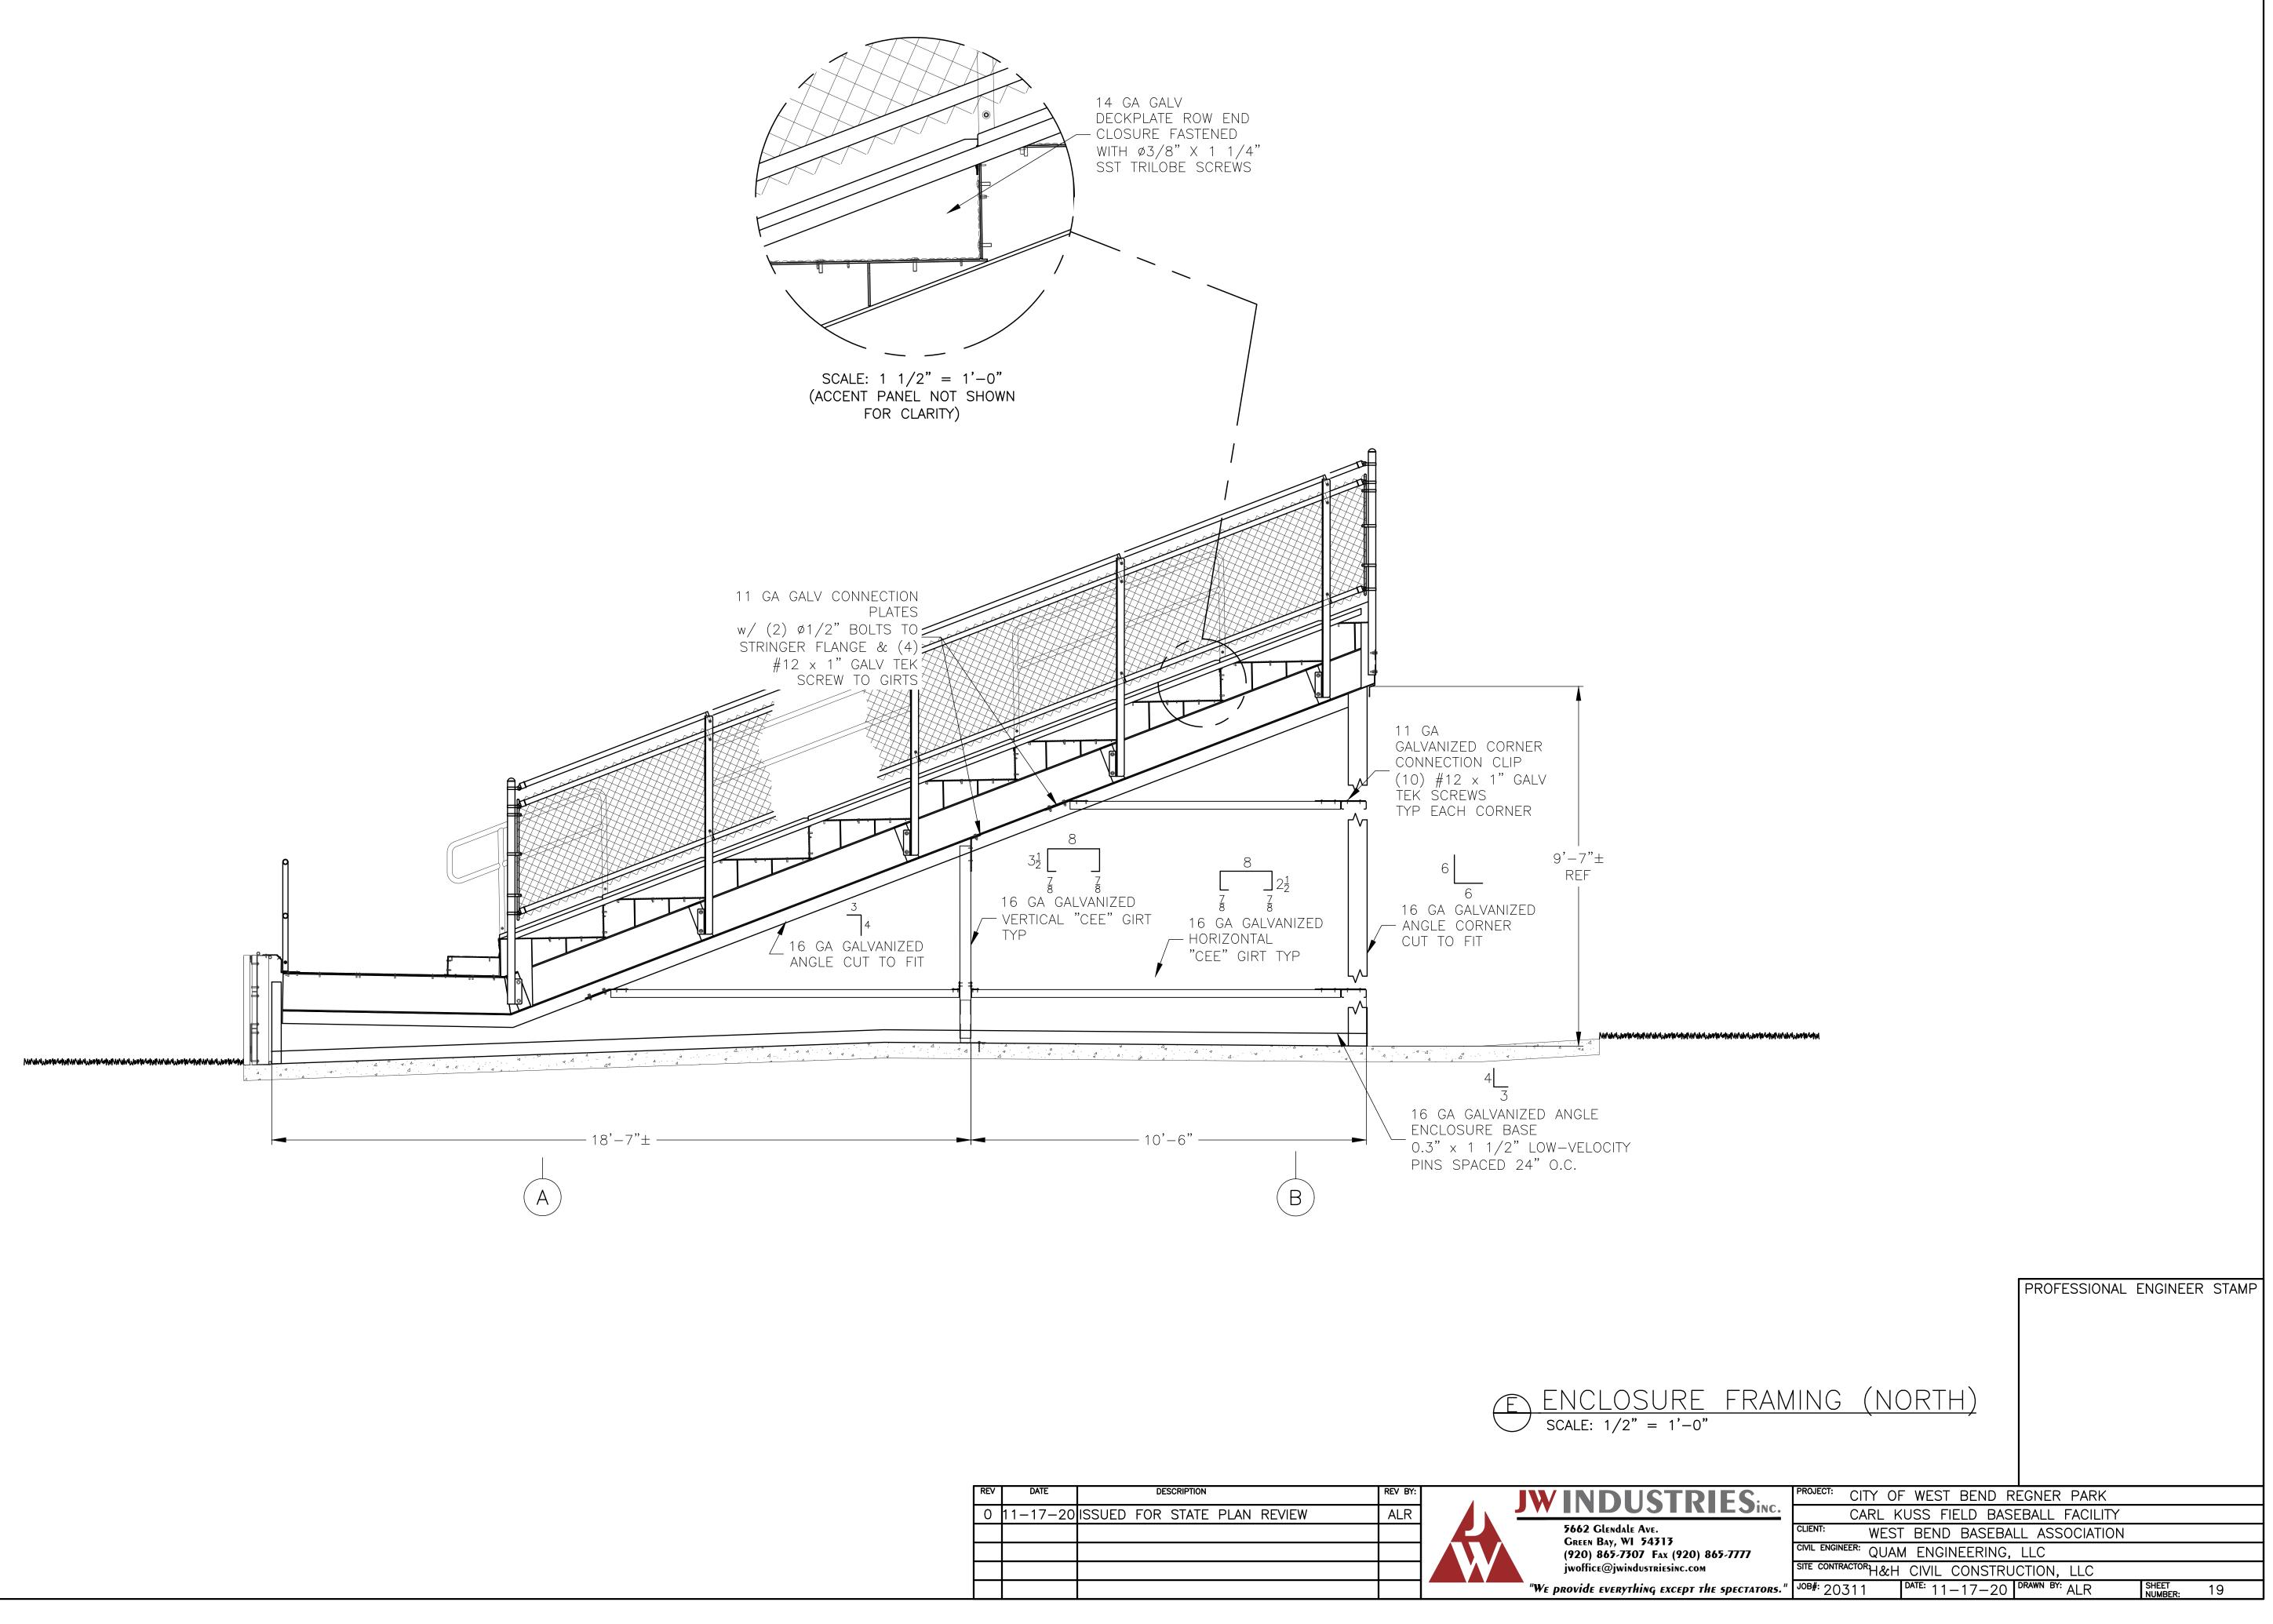

REV	DATE		DESCRIPTION			REV BY:	
0	11-17-20	ISSUED FOF	R STATE	PLAN	REVIEW	ALR	
							L

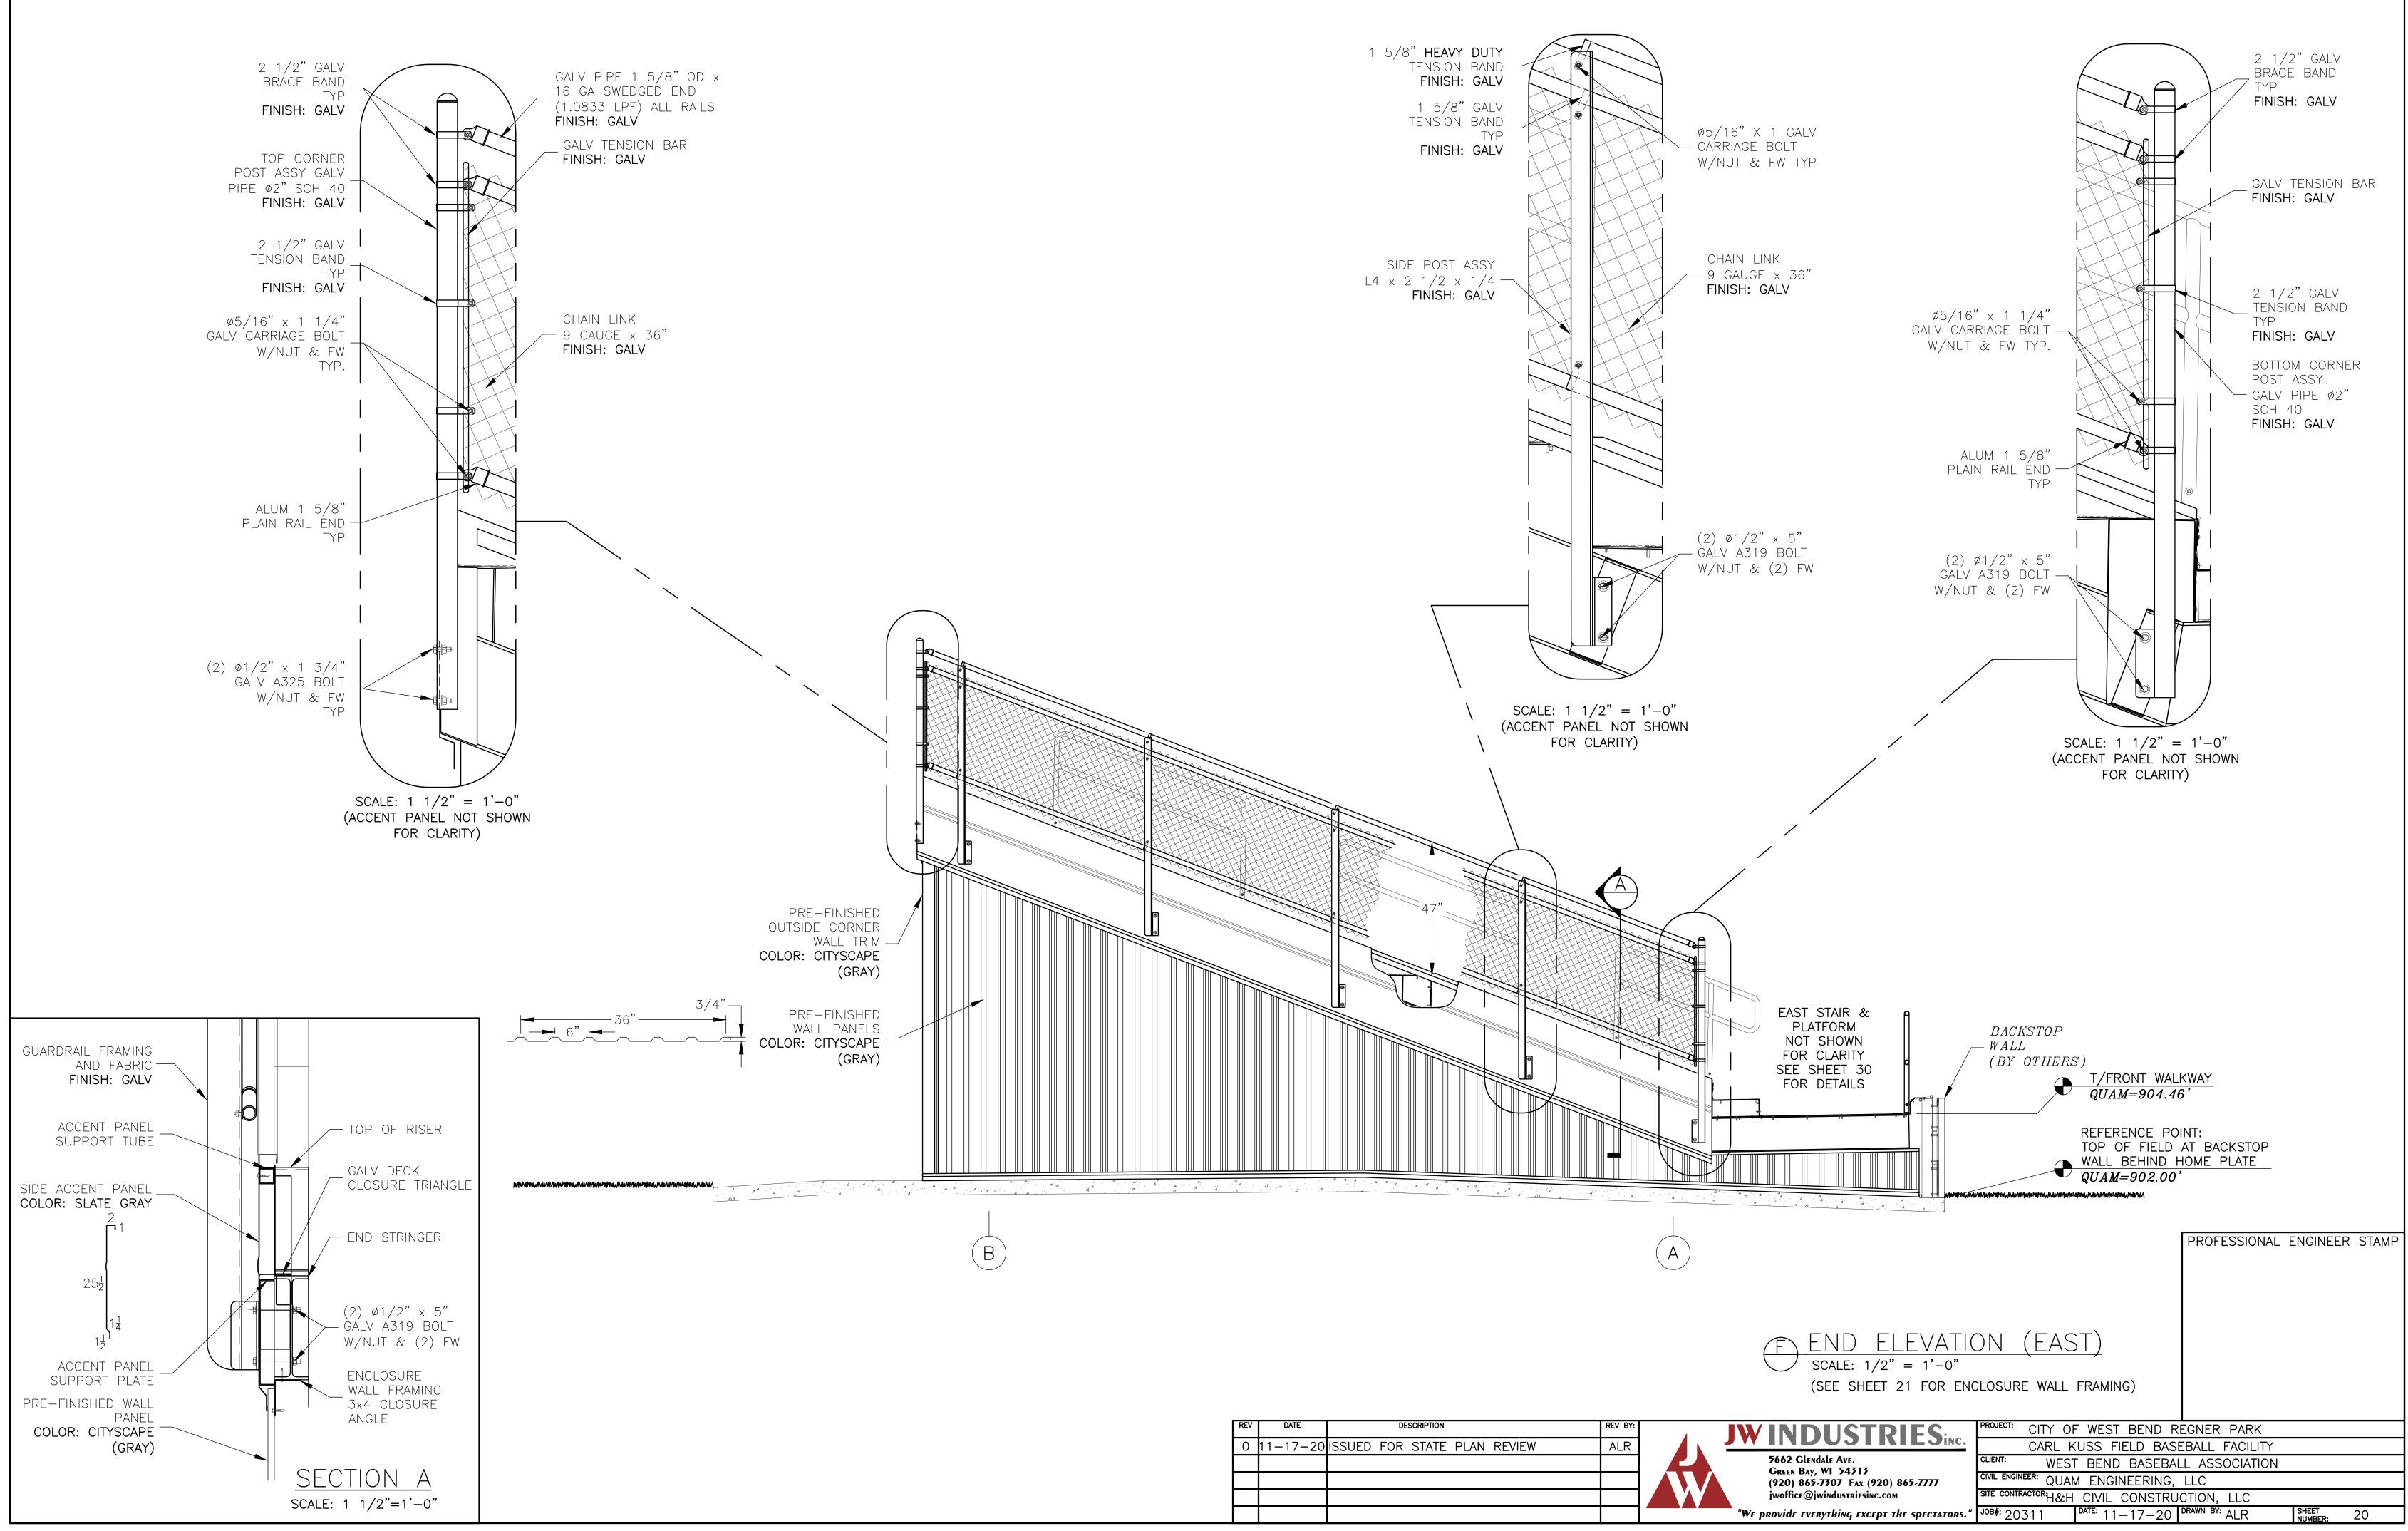


REV	DATE	DESCRIPTION	REV BY:	4
0	11-17-20	ISSUED FOR STATE PLAN REVIEW	ALR	

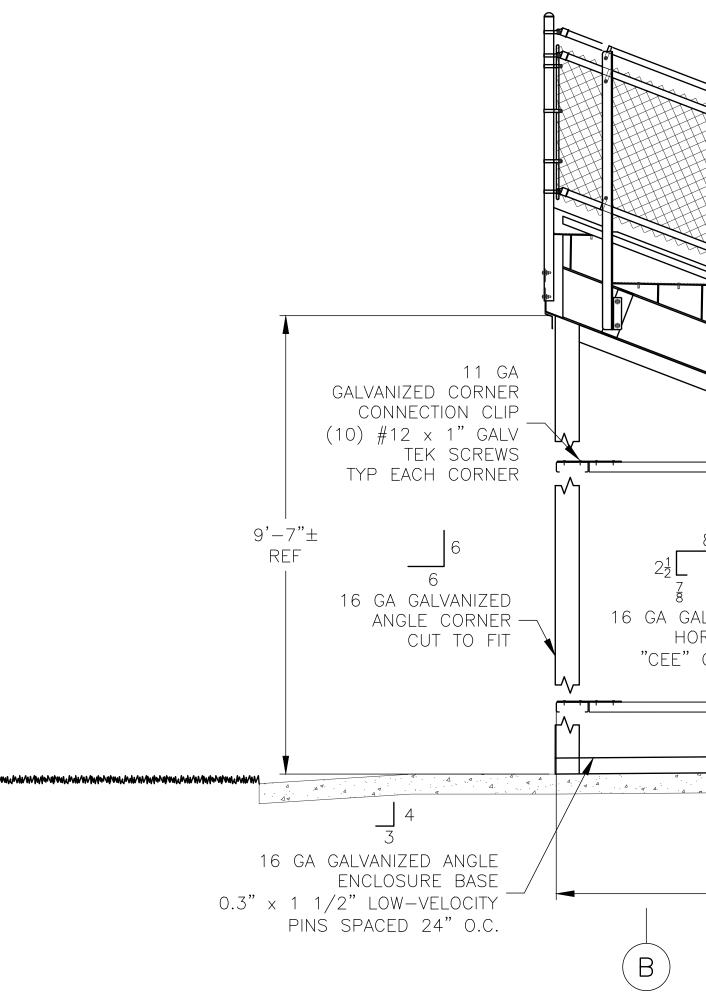


14 GA GALV DECKPLATE ROW END CLOSURE FASTENED WITH Ø3/8" X 1 1/4" SST TRILOBE SCREWS	
ACCENT PA	1/2" = 1'-0" NEL NOT SHOWN CLARITY)
	11 GA GALV CONNECTION PLATES w/ (2) ø1/2" BOLTS TO STRINGER FLANGE & (4) #12 x 1" GALV TEK SCREW TO GIRTS
8 2 <sup>1</sup> / <sub>2</sub> 3 <sup>1</sup> / <sub>2</sub> 16 GA GALVANIZED HORIZONTAL "CEE" GIRT TYP TYP	16 GA GALVANIZED ANGLE CUT TO FIT
■ 10'-6" ■ ■	18'-7"±


REV	DATE	DESCRIPTION	REV BY:	
0	11-17-20	ISSUED FOR STATE PLAN REVIEW	ALR	


		(-T)	PROFESSIONAL	ENGINEER	STAMP
ENCLOSURE FRAM scale: 1/2" = 1'-0"					
JWINDUSTRIES	PROJECT: CITY OF	F WEST BEND RI USS FIELD BASE			
5662 Glendale Ave. Green Bay, WI 54313	CLIENT: WEST		L ASSOCIATION		
(920) 865-7307 Fax (920) 865-7777 jwoffice@jwindustriesinc.com		I ENGINEERING, CIVIL CONSTRU			
"We provide everything except the spectators."	J <sup>OB#:</sup> 20311	DATE: 11-17-20	DRAWN BY: ALR	SHEET NUMBER:	21

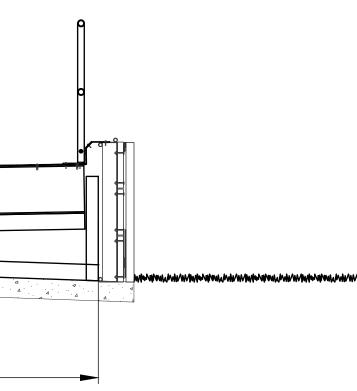

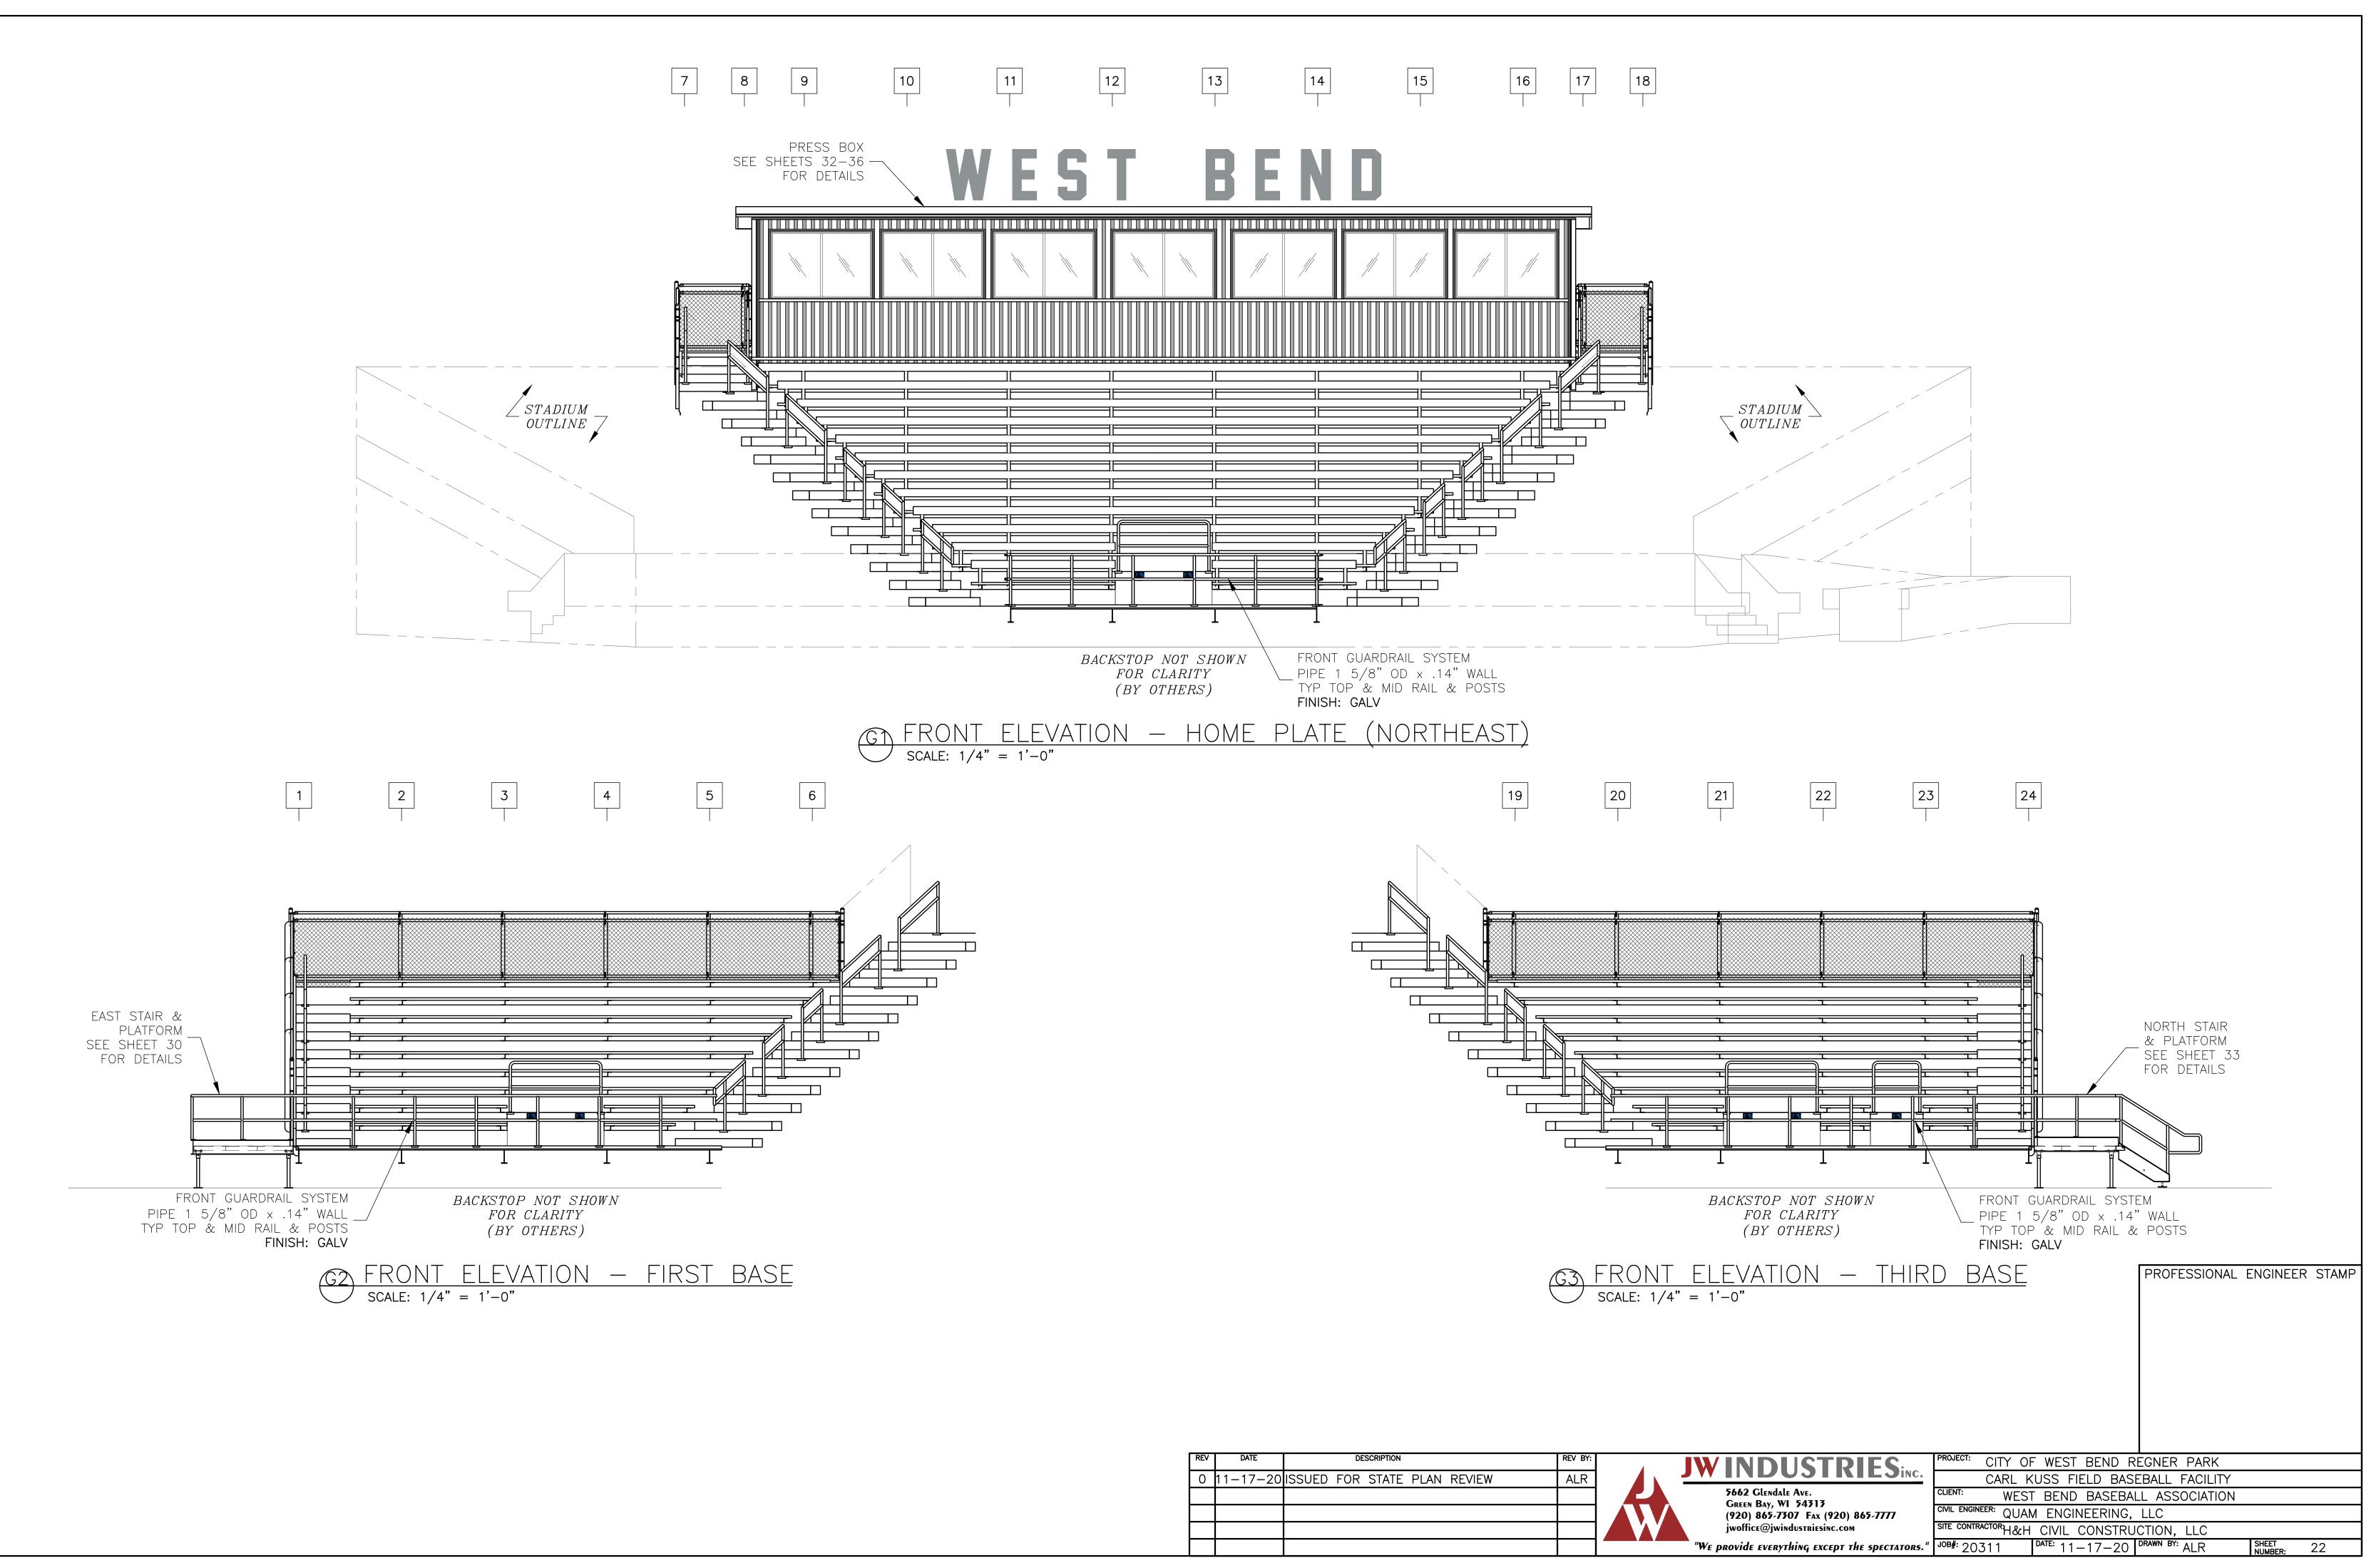


	REV BY:			SCRIPTION	DE		DATE	REV
	ALR	REVIEW	PLAN	STATE	FOR	ISSUED	1-17-20	0
L								
l Andri								

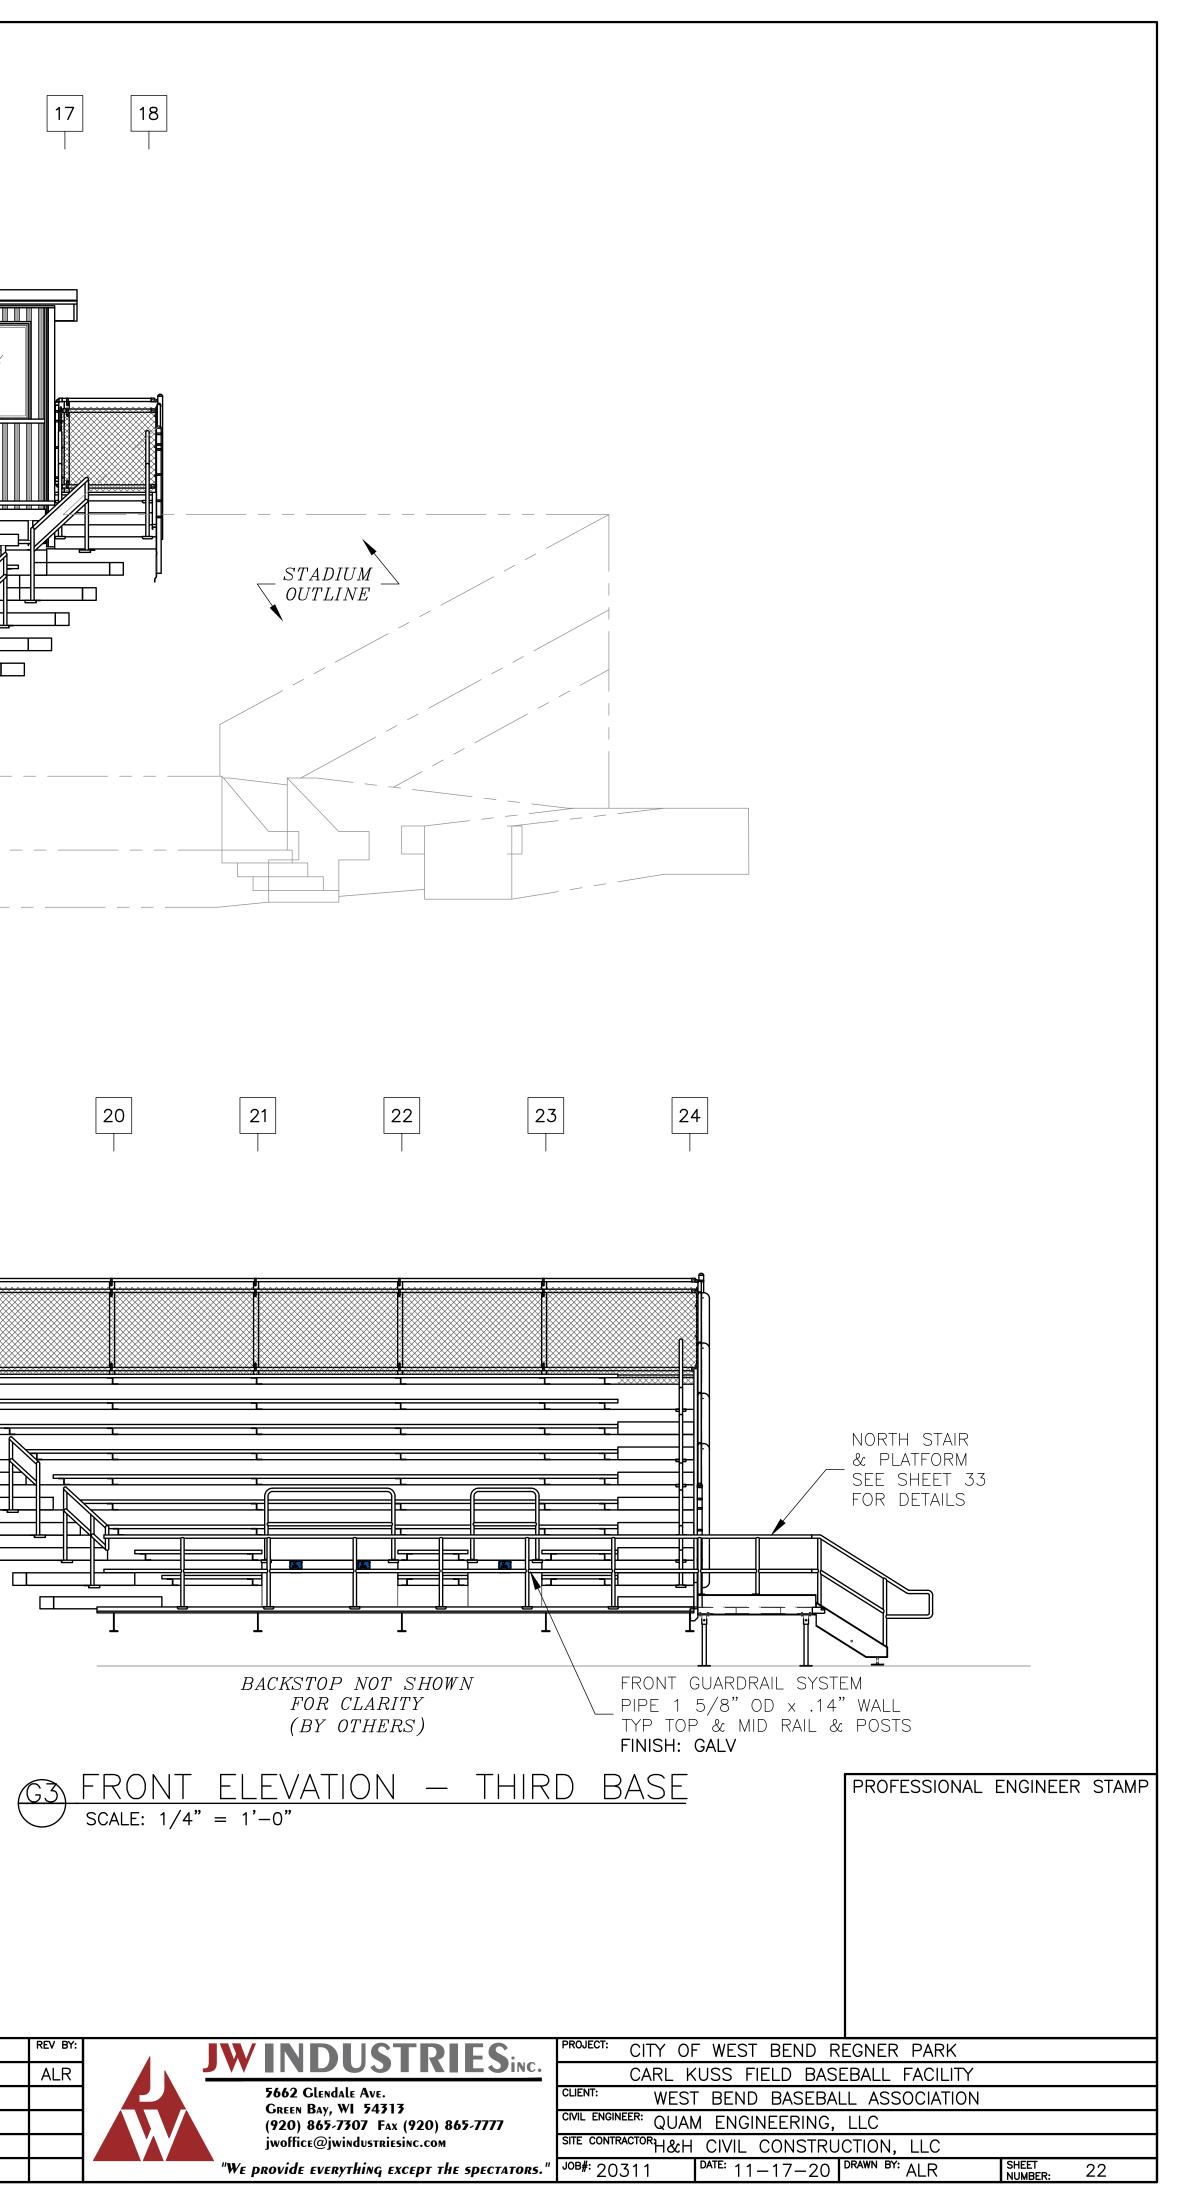


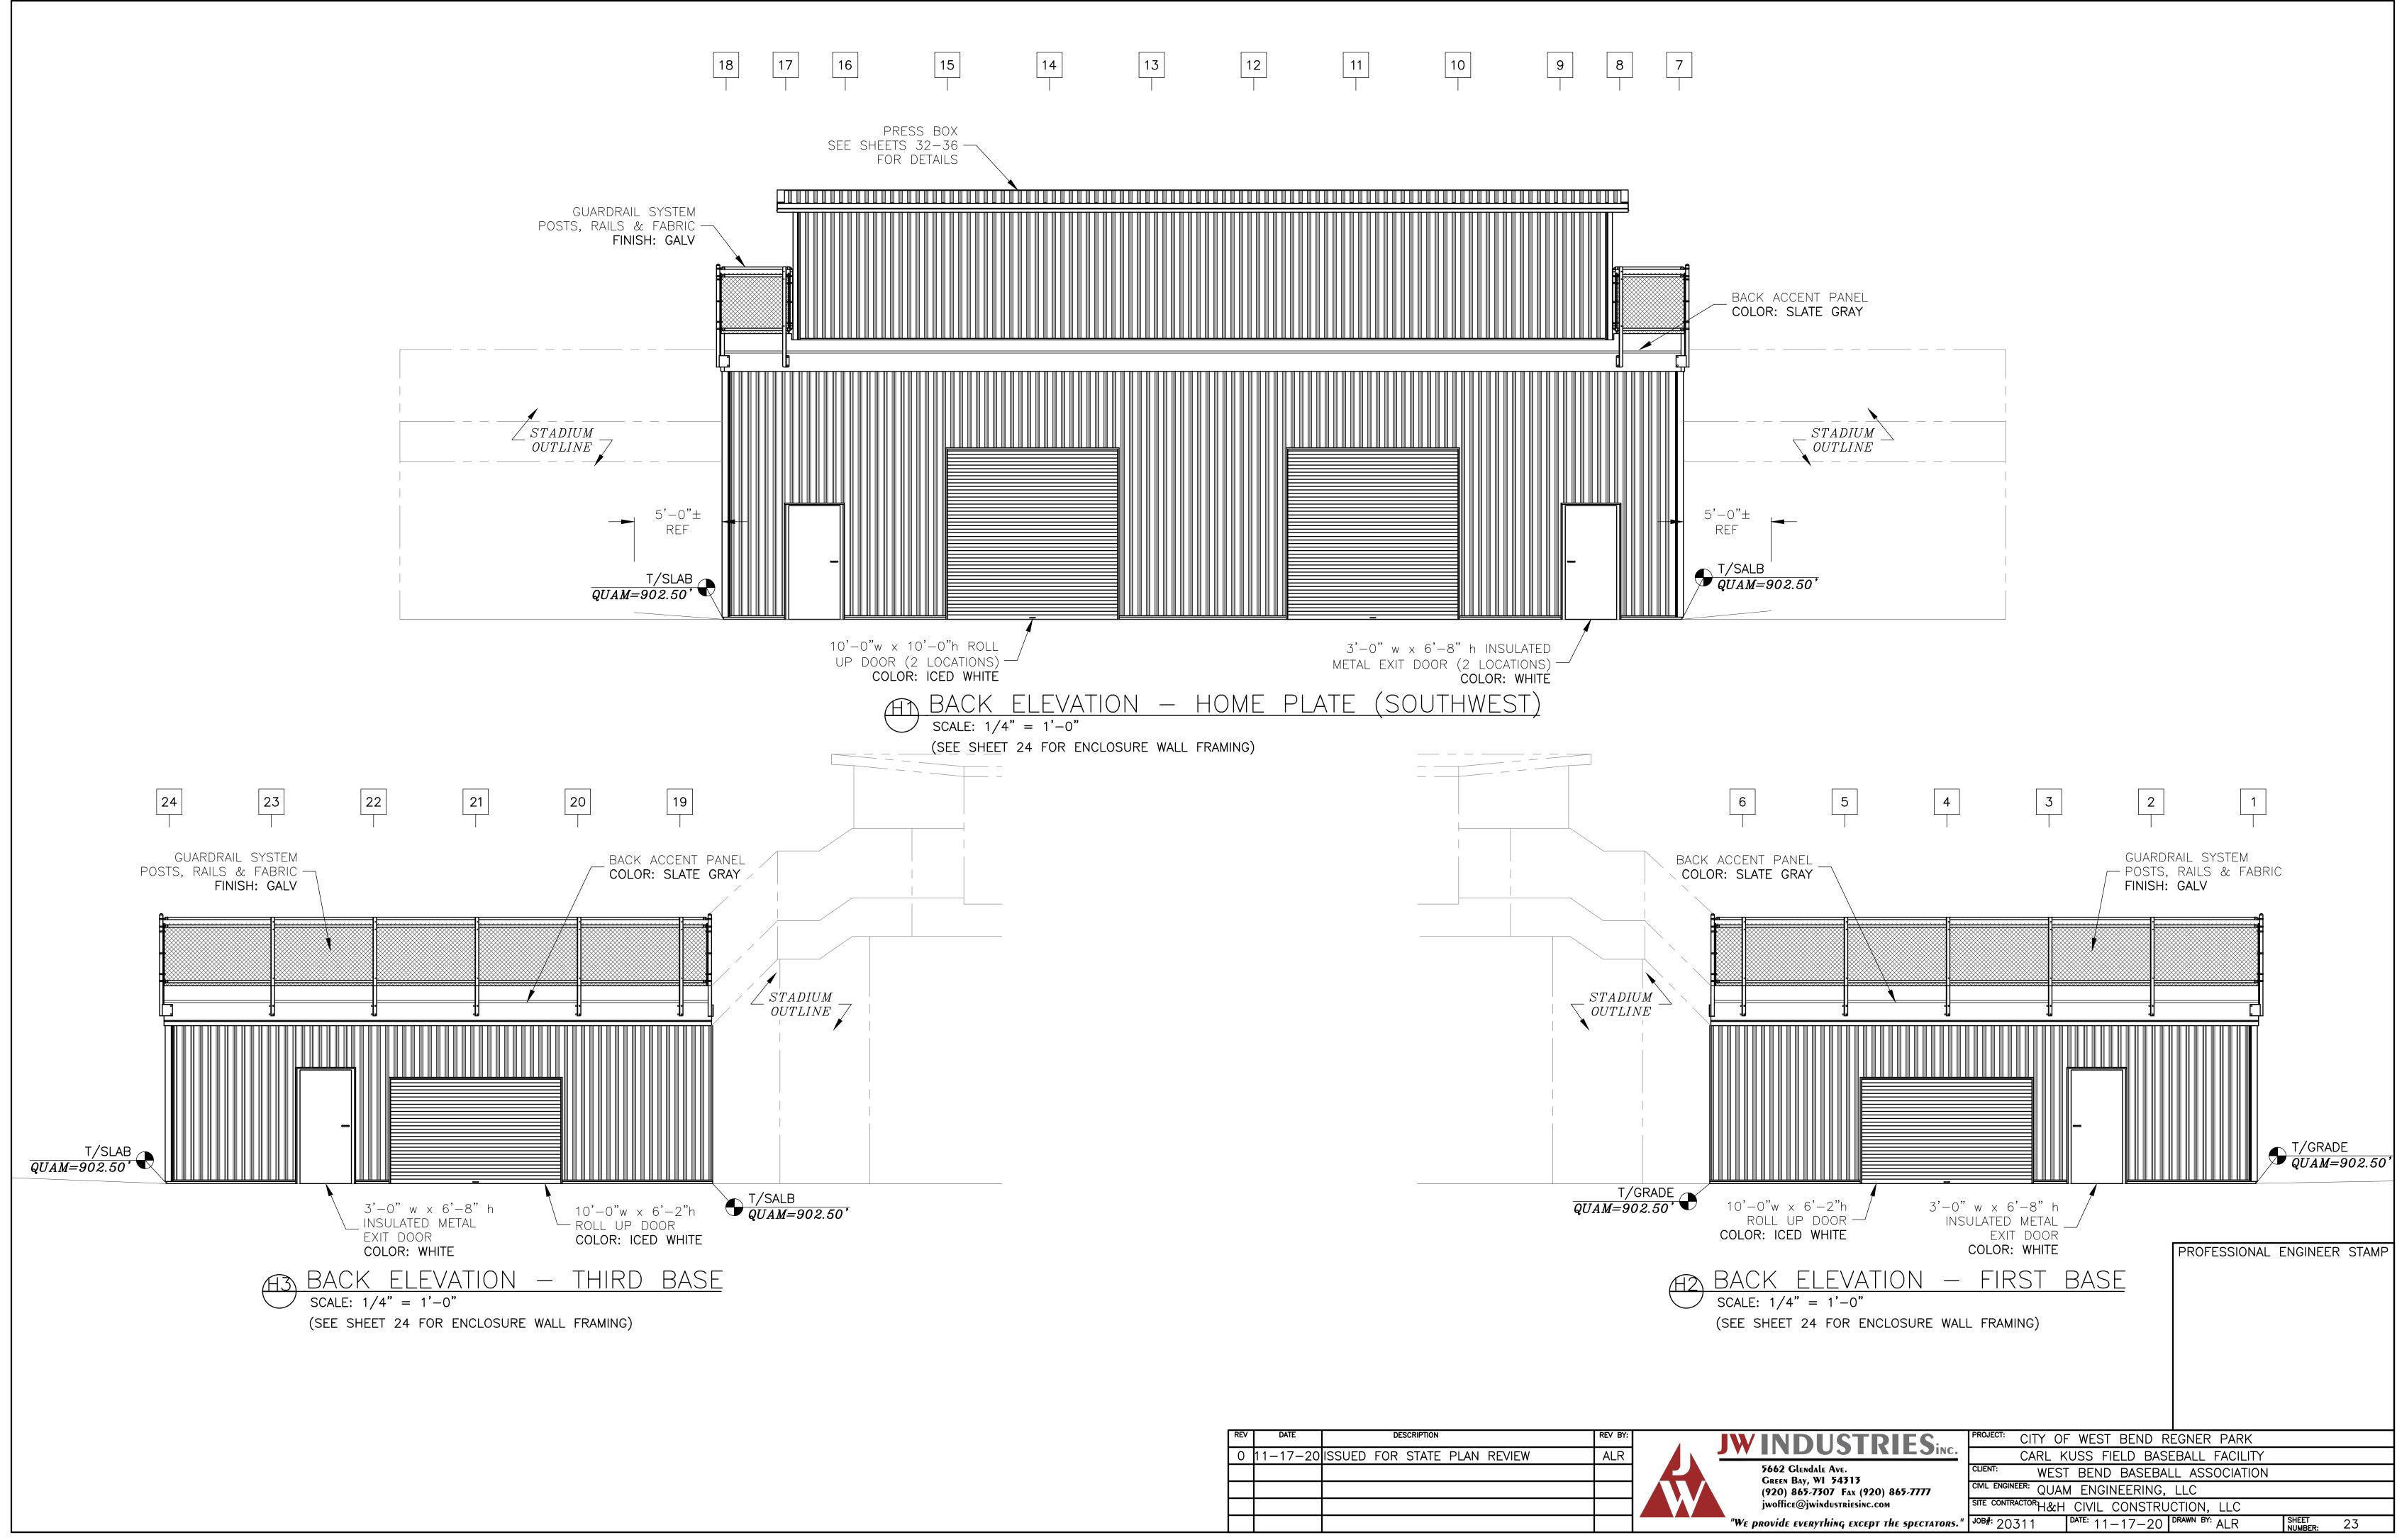


REV	DATE	DESCRIPTION	REV BY:	
0	11-17-20	ISSUED FOR STATE PLAN REVIEW	ALR	
				<b>F</b>

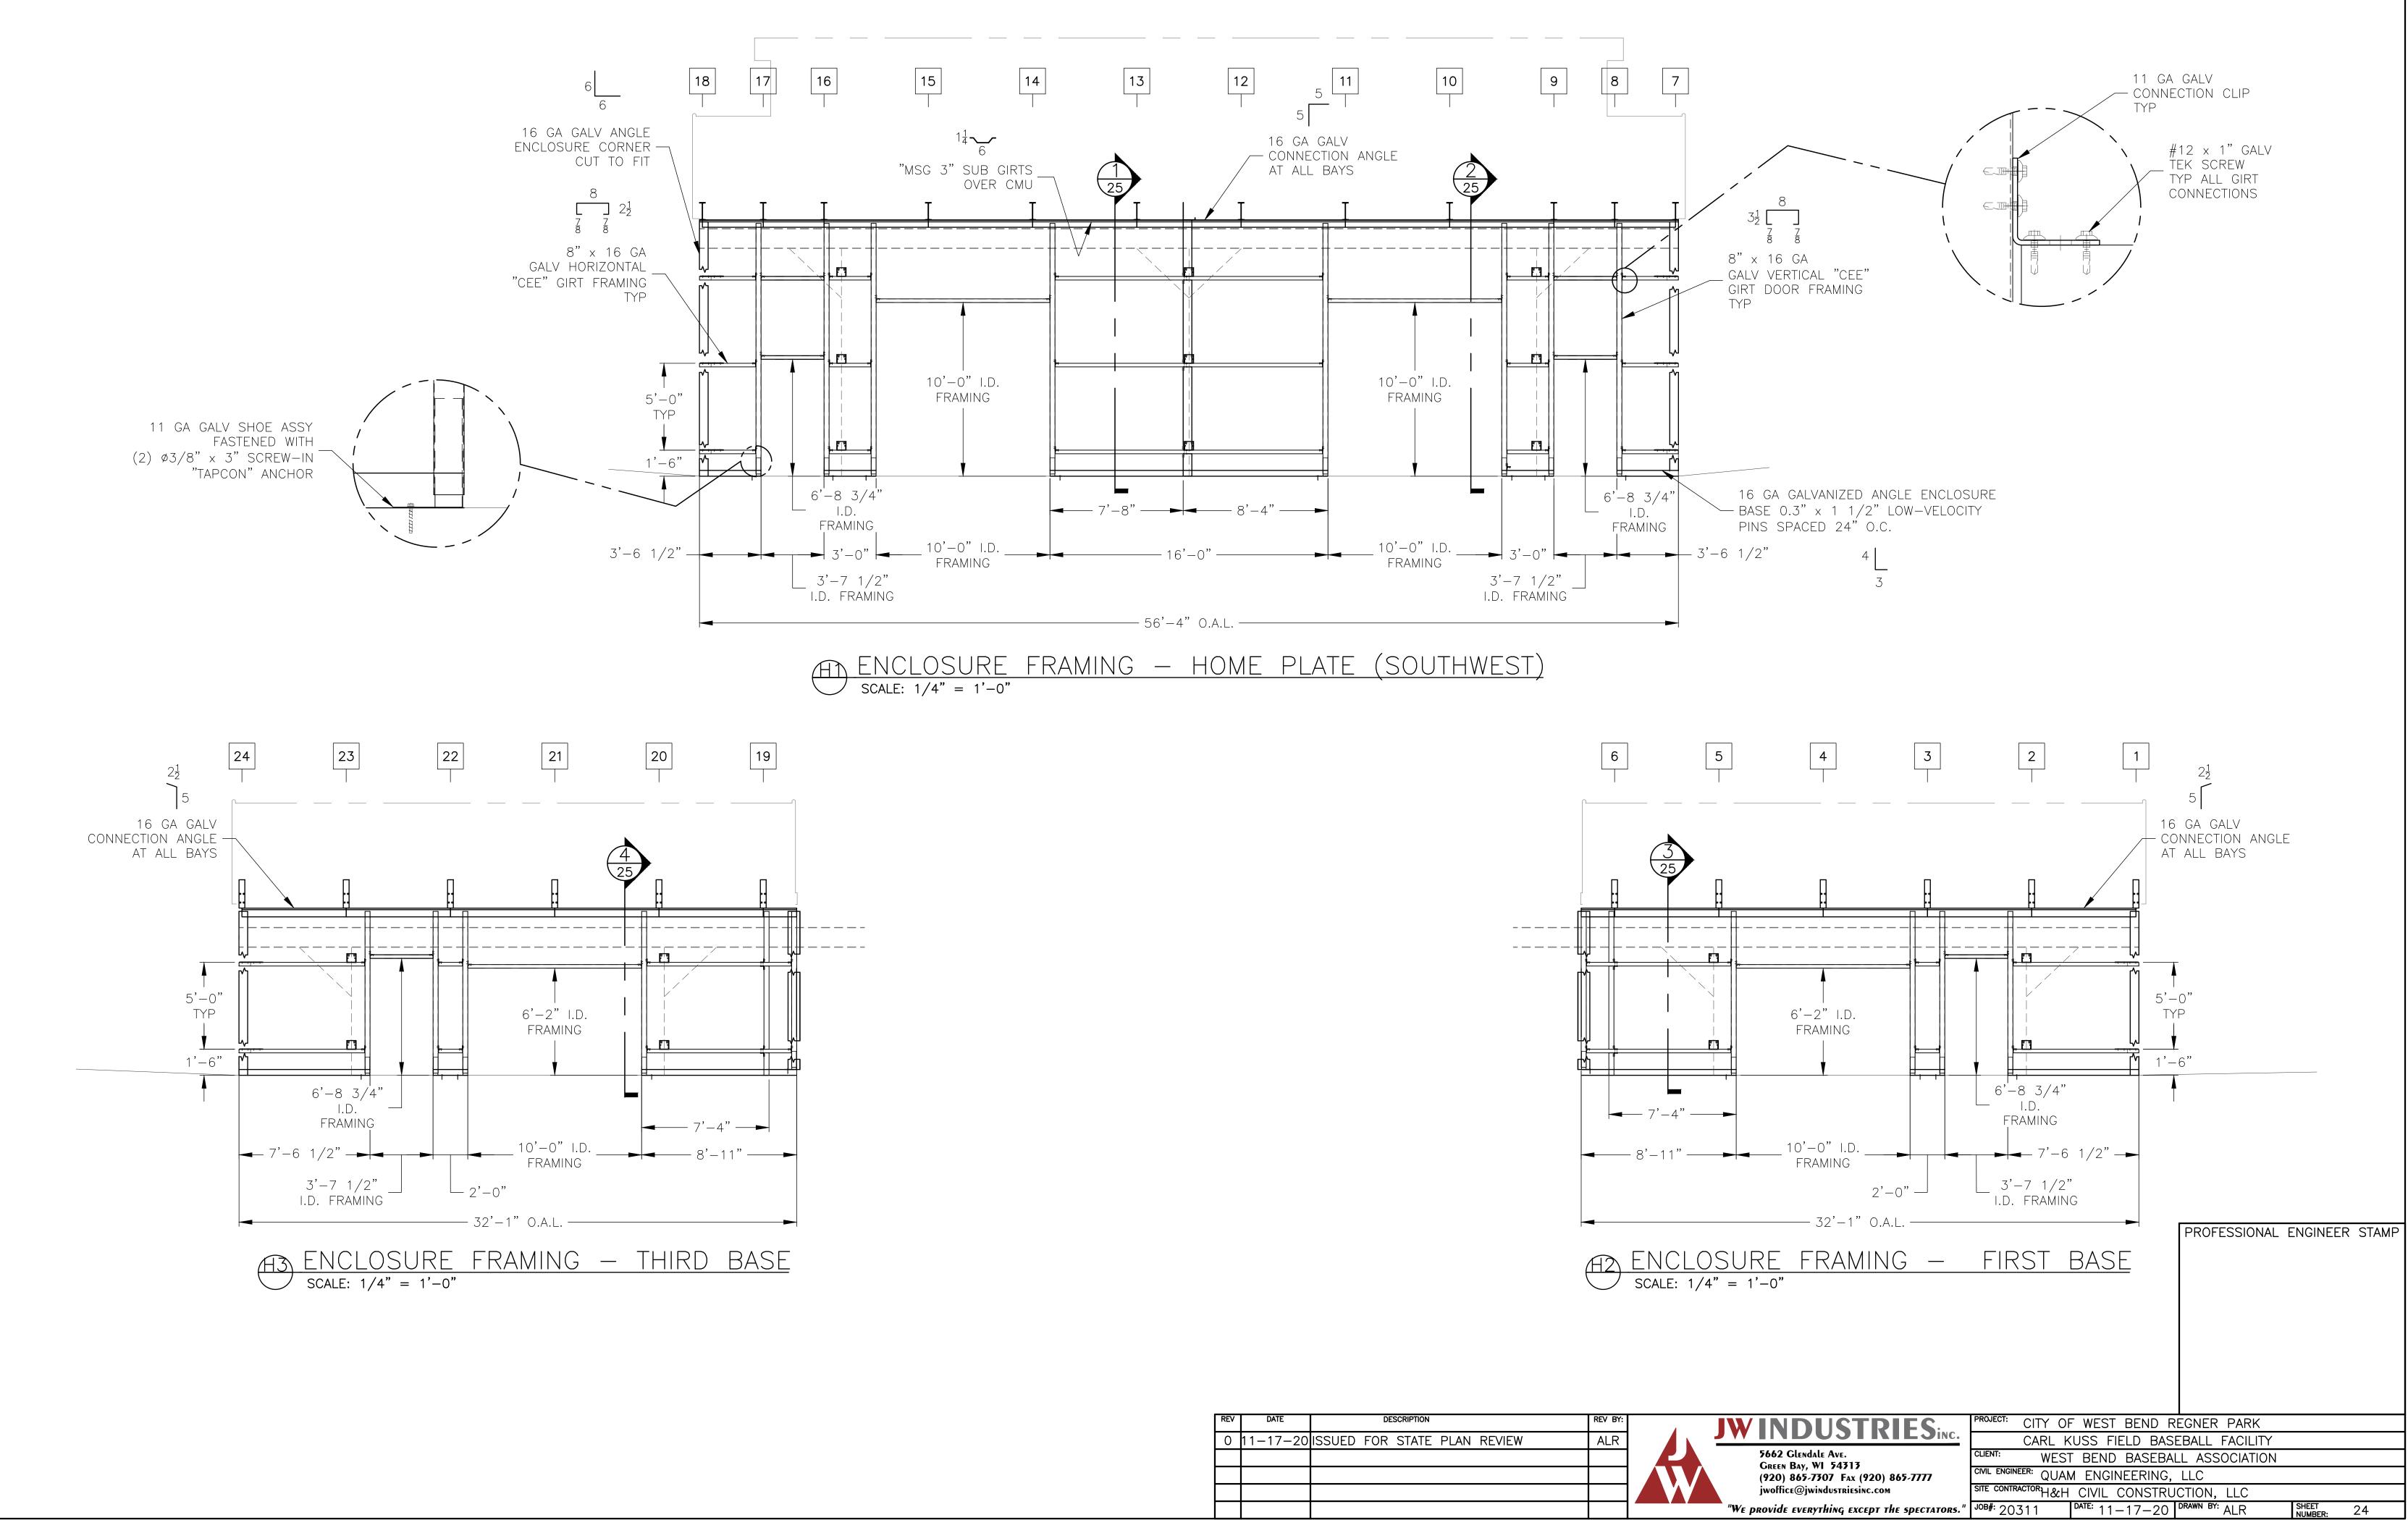


REV	DATE	DESCRIPTION	REV BY:	
$\cap$	11 - 17 - 20	ISSUED FOR STATE PLAN REVIEW		
0	11 17 20	ISSUED FOR STATE FEAR REVIEW		
			<b></b>	

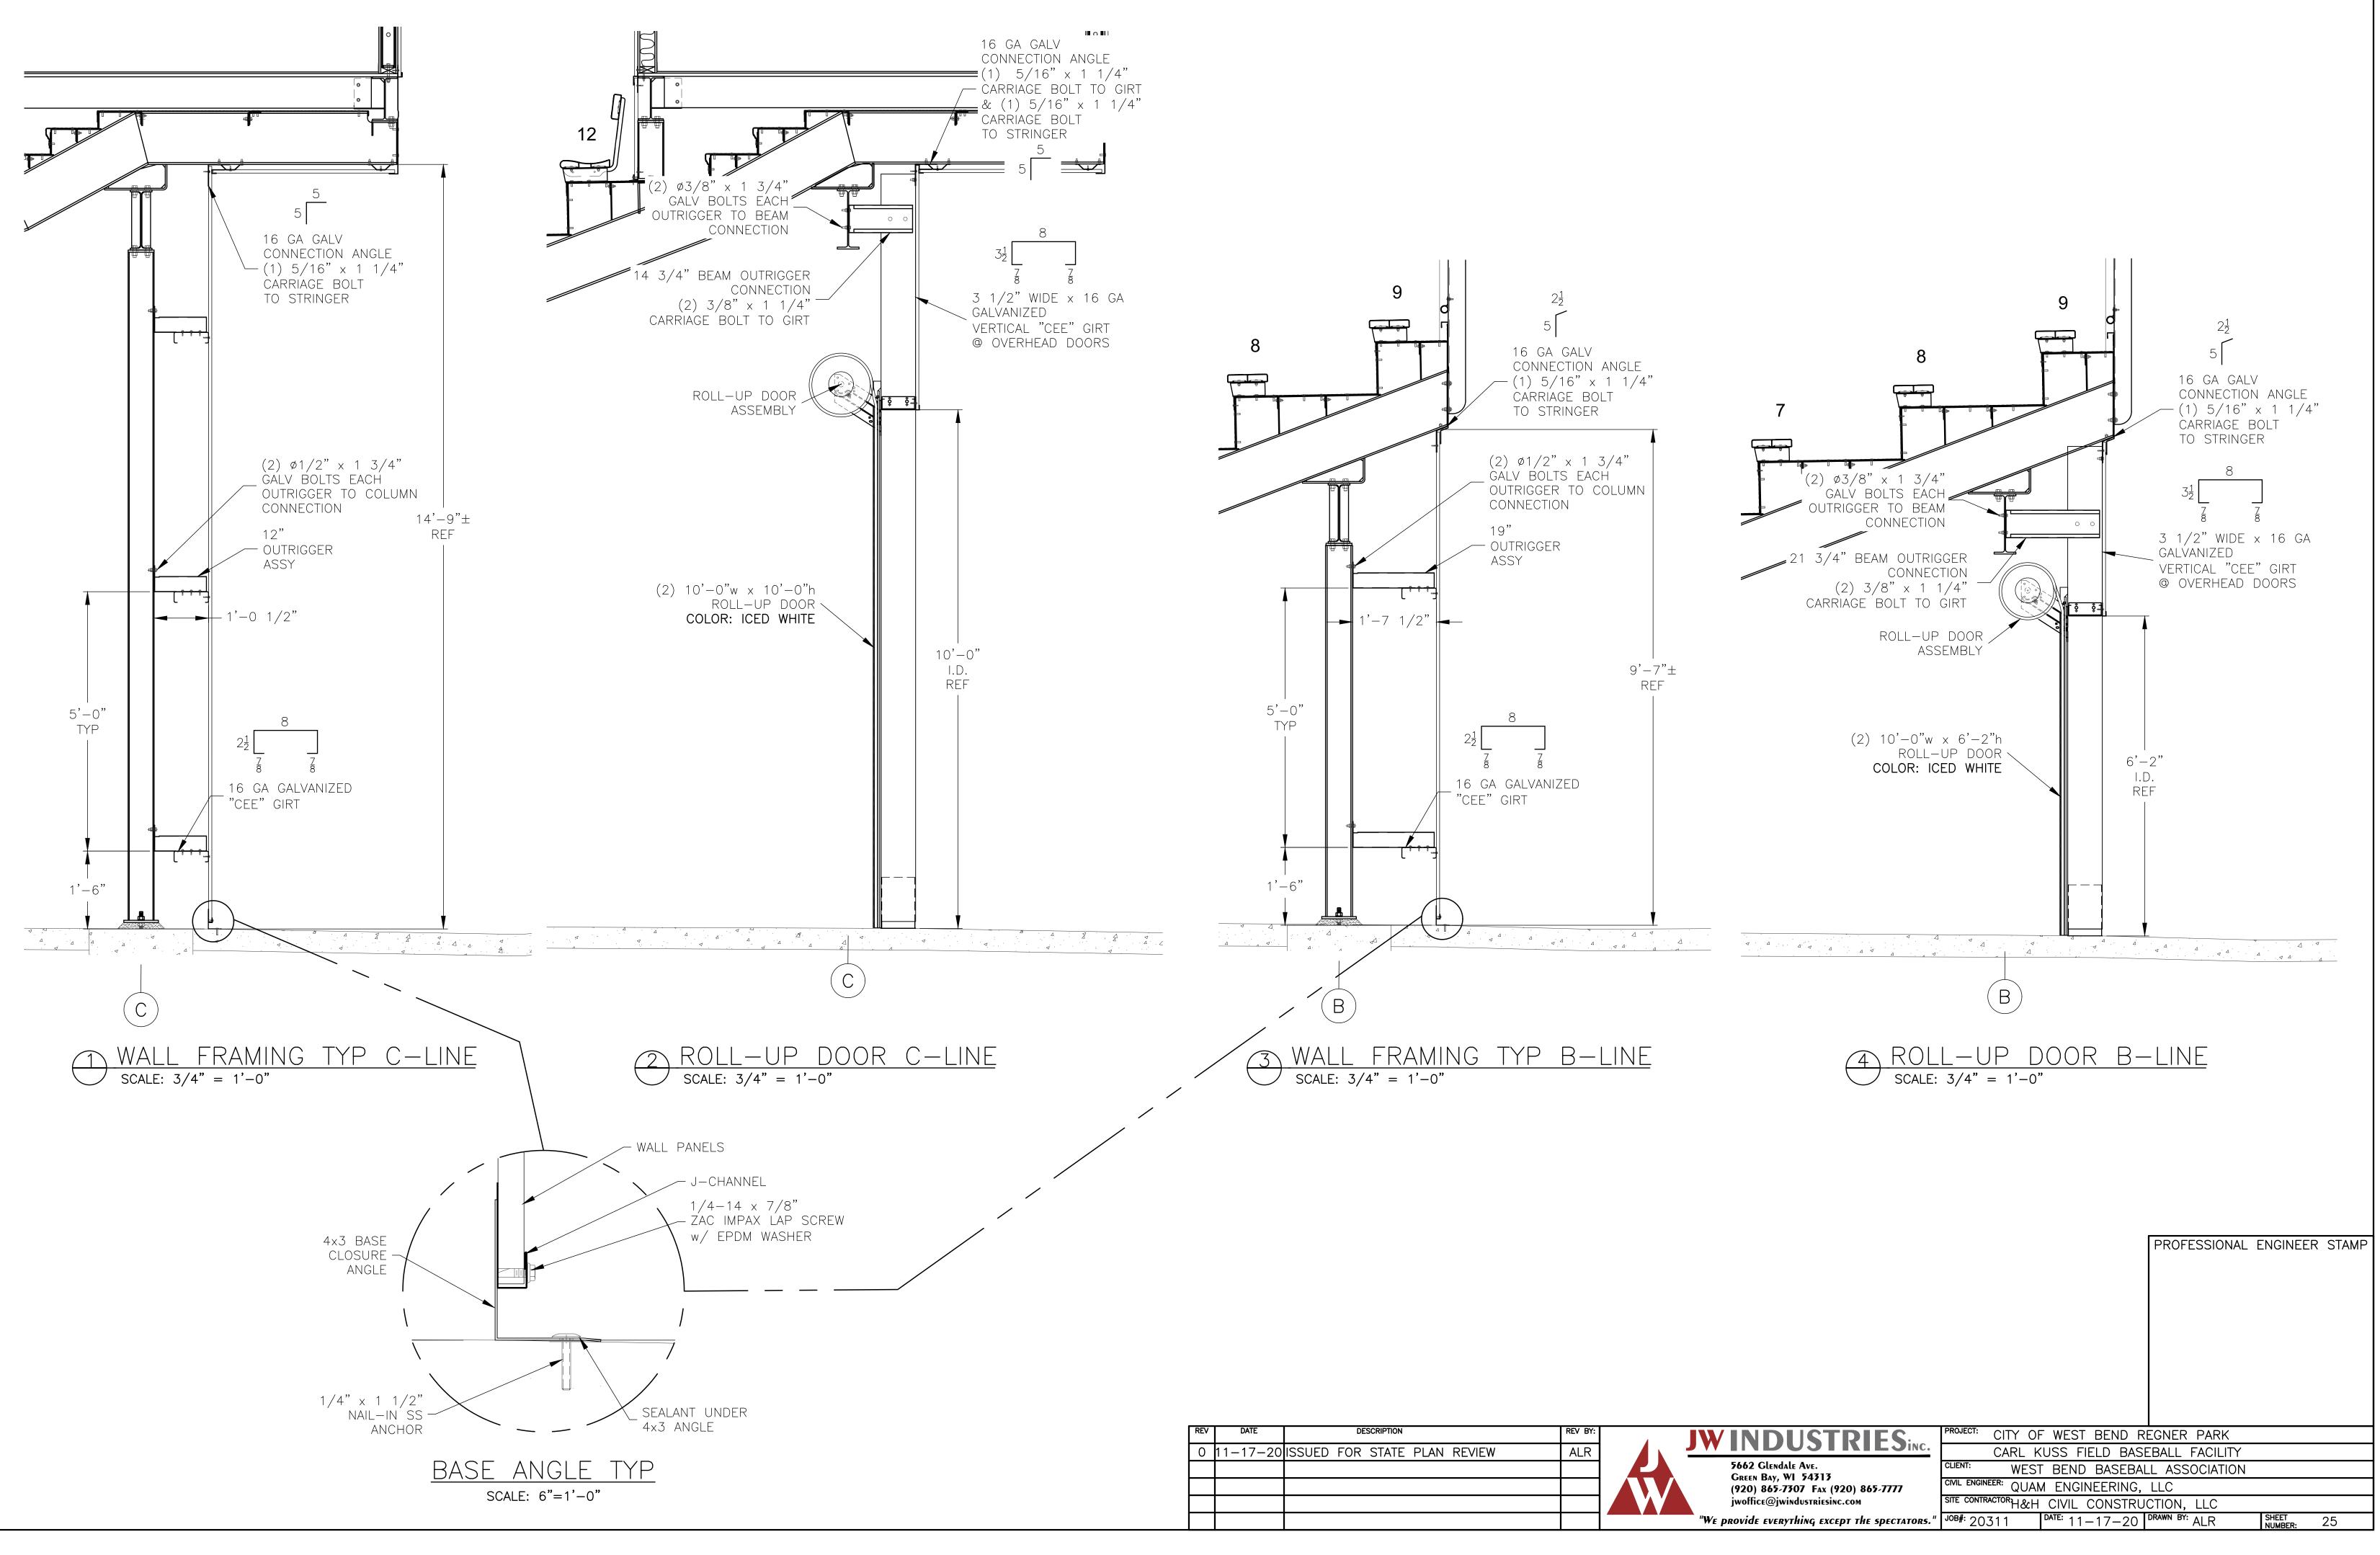



ĺ	REV	DATE	DESCRIPTION	REV BY:	
	0	11–17–20	ISSUED FOR STATE PLAN REVIEW	ALR	
					Ļ

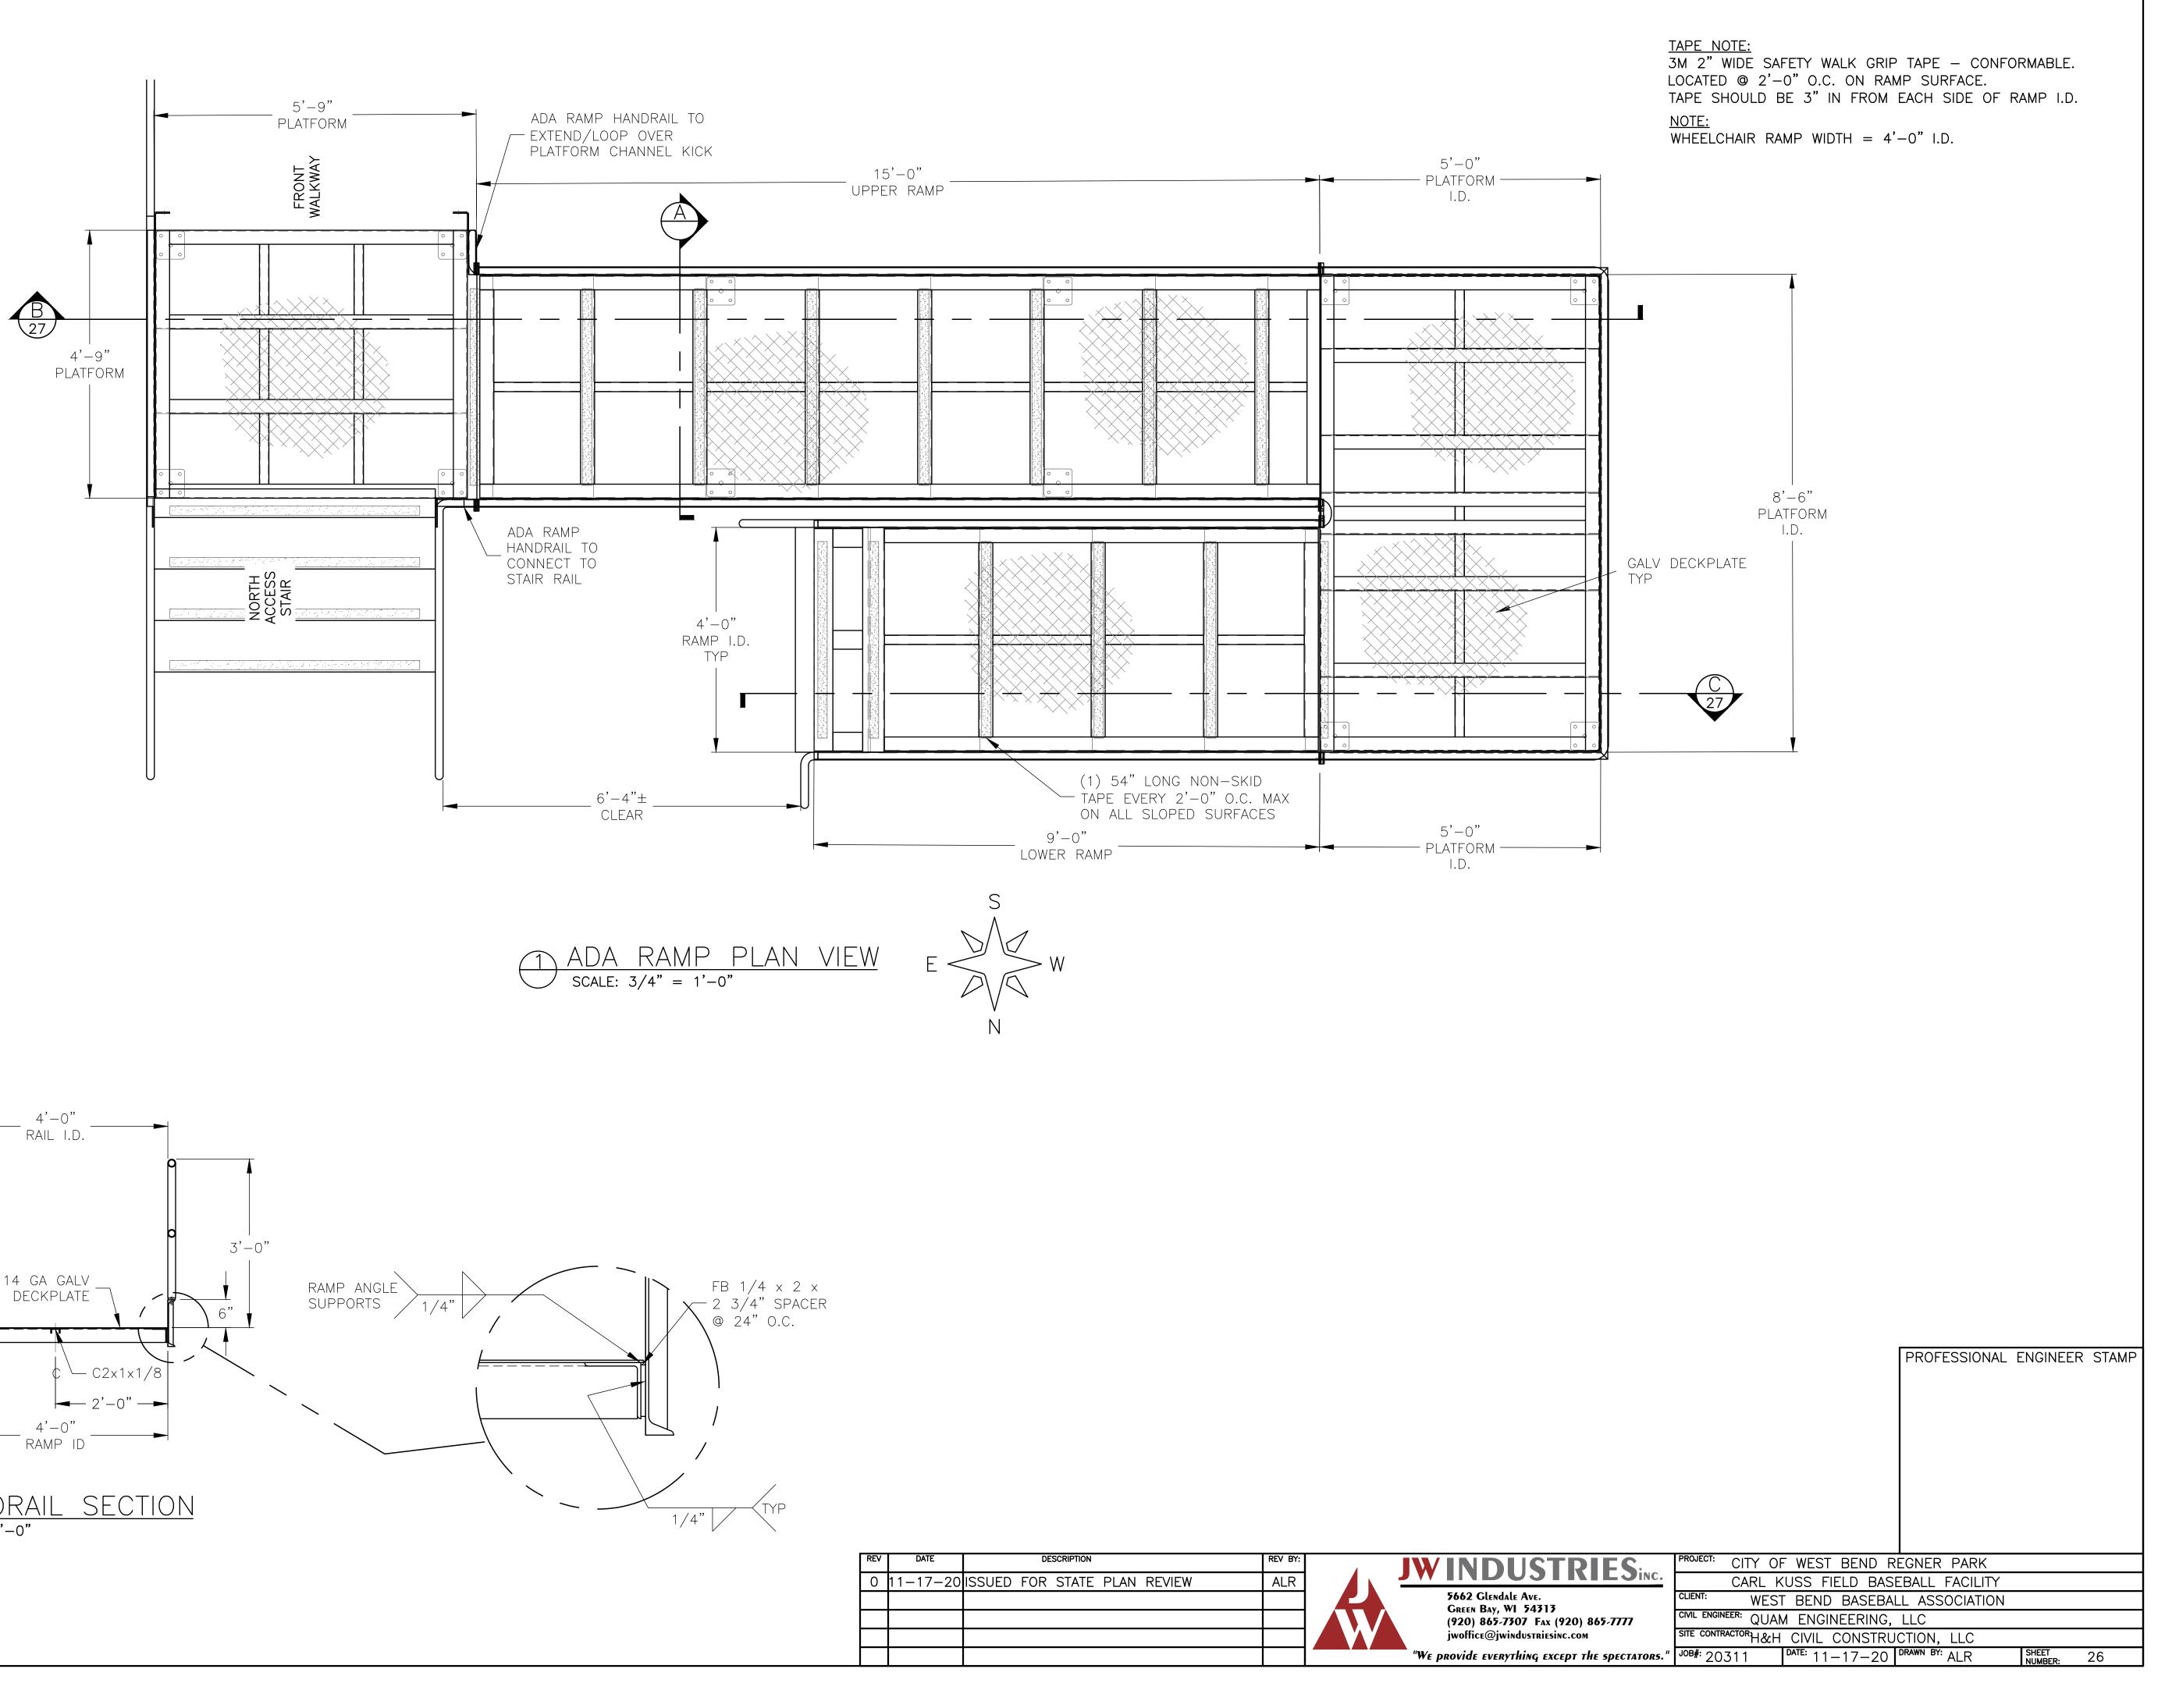

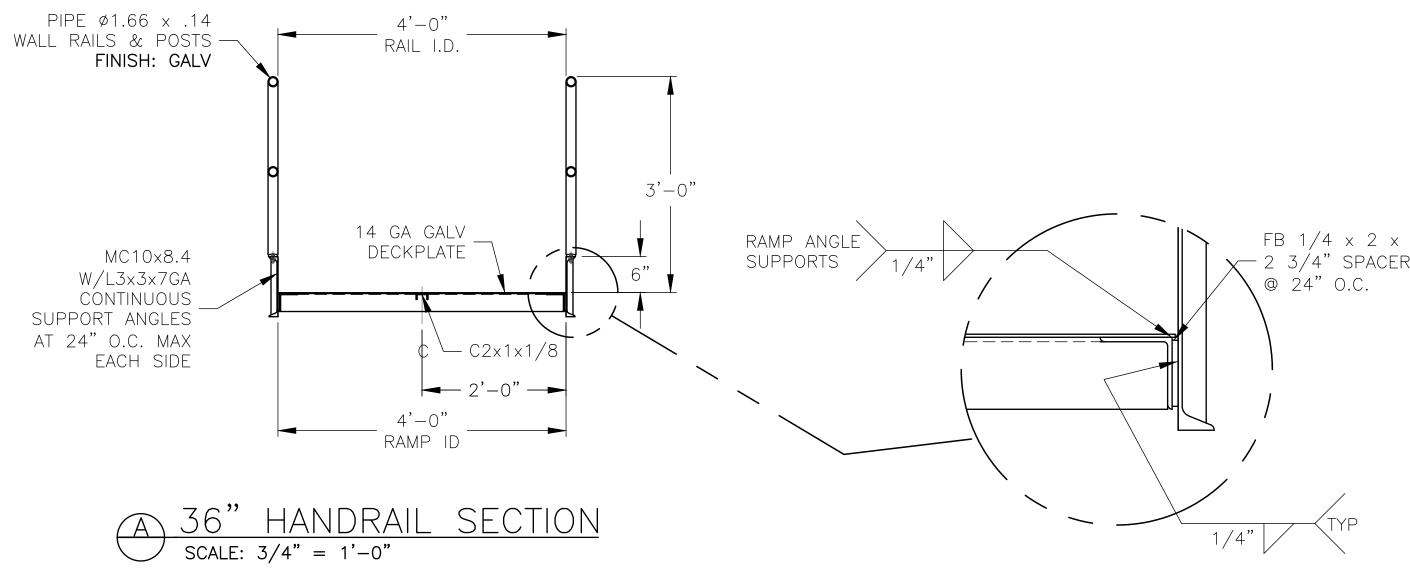


Γ	REV	DATE	DESCRIPTION	REV BY:	
	0	11-17-20	ISSUED FOR STATE PLAN REVIEW	ALR	
					Ļ

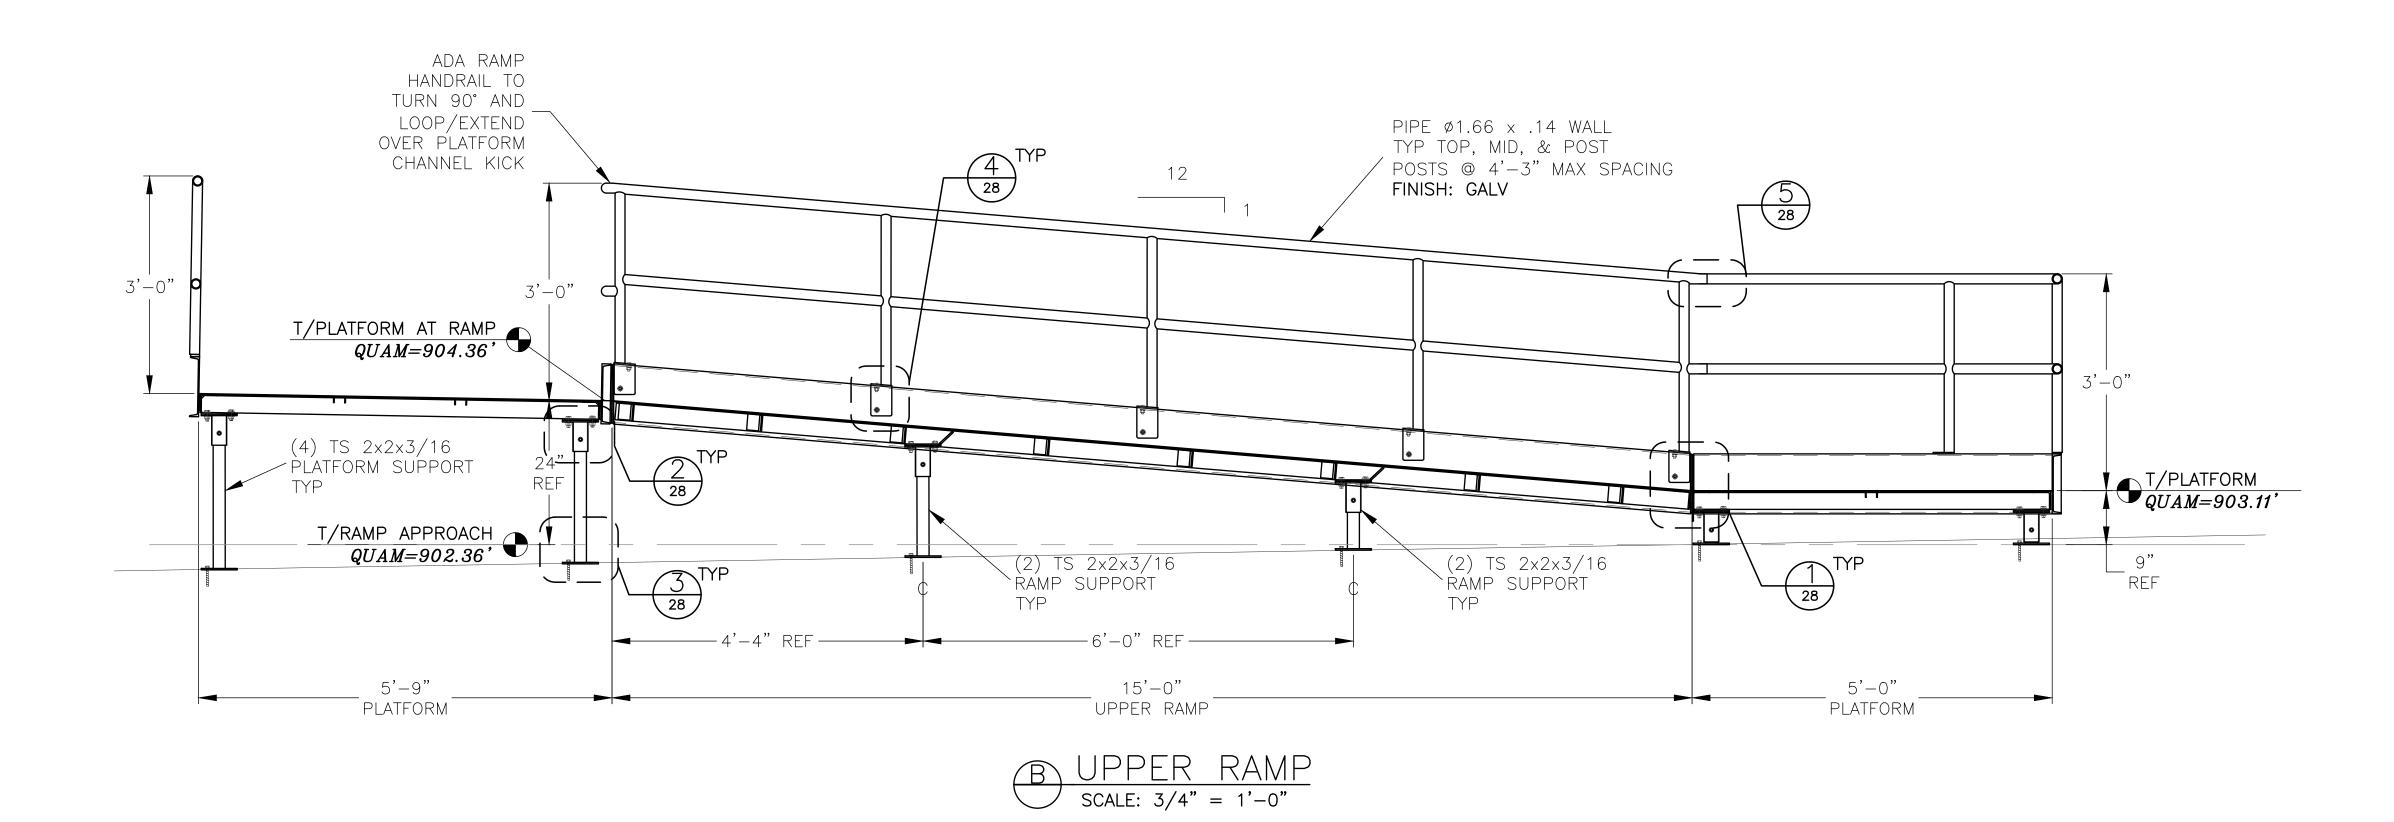

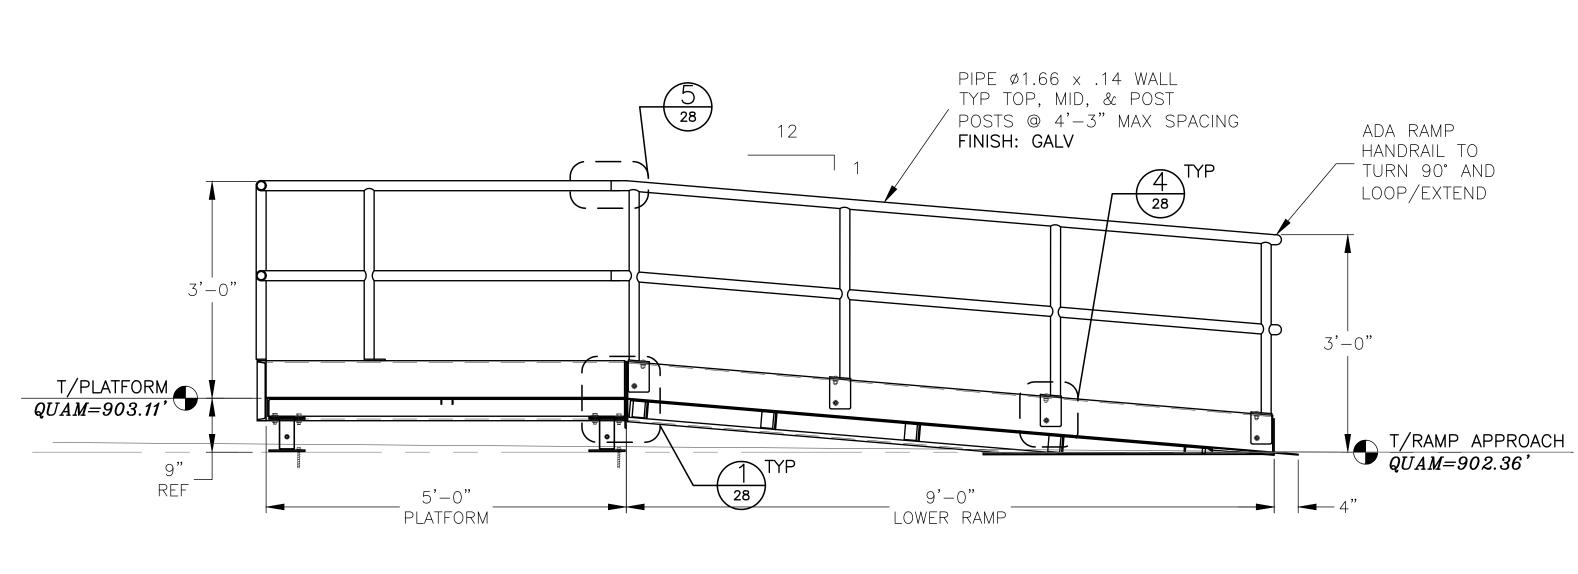


REV BY:		DESCRIPTION	DATE	REV
ALR	PLAN REVIEW	ISSUED FOR STATE	11-17-20	0

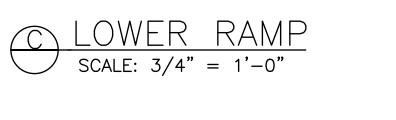


ROJECT: CITY OF WEST BEND REGNER PARK JWINDUSTRIES CARL KUSS FIELD BASEBALL FACILITY 5662 Glendale Ave. WEST BEND BASEBALL ASSOCIATION CLIENT: GREEN BAY, WI 54313 CIML ENGINEER: QUAM ENGINEERING, LLC (920) 865-7307 Fax (920) 865-7777 jwoffice@jwindustriesinc.com SITE CONTRACTOR H&H CIVIL CONSTRUCTION, LLC "We provide everything except the spectators." JOB#: 20311 DATE: 11-17-20 DRAWN BY: ALR SHEET 27


PROFESSIONAL ENGINEER STAMP

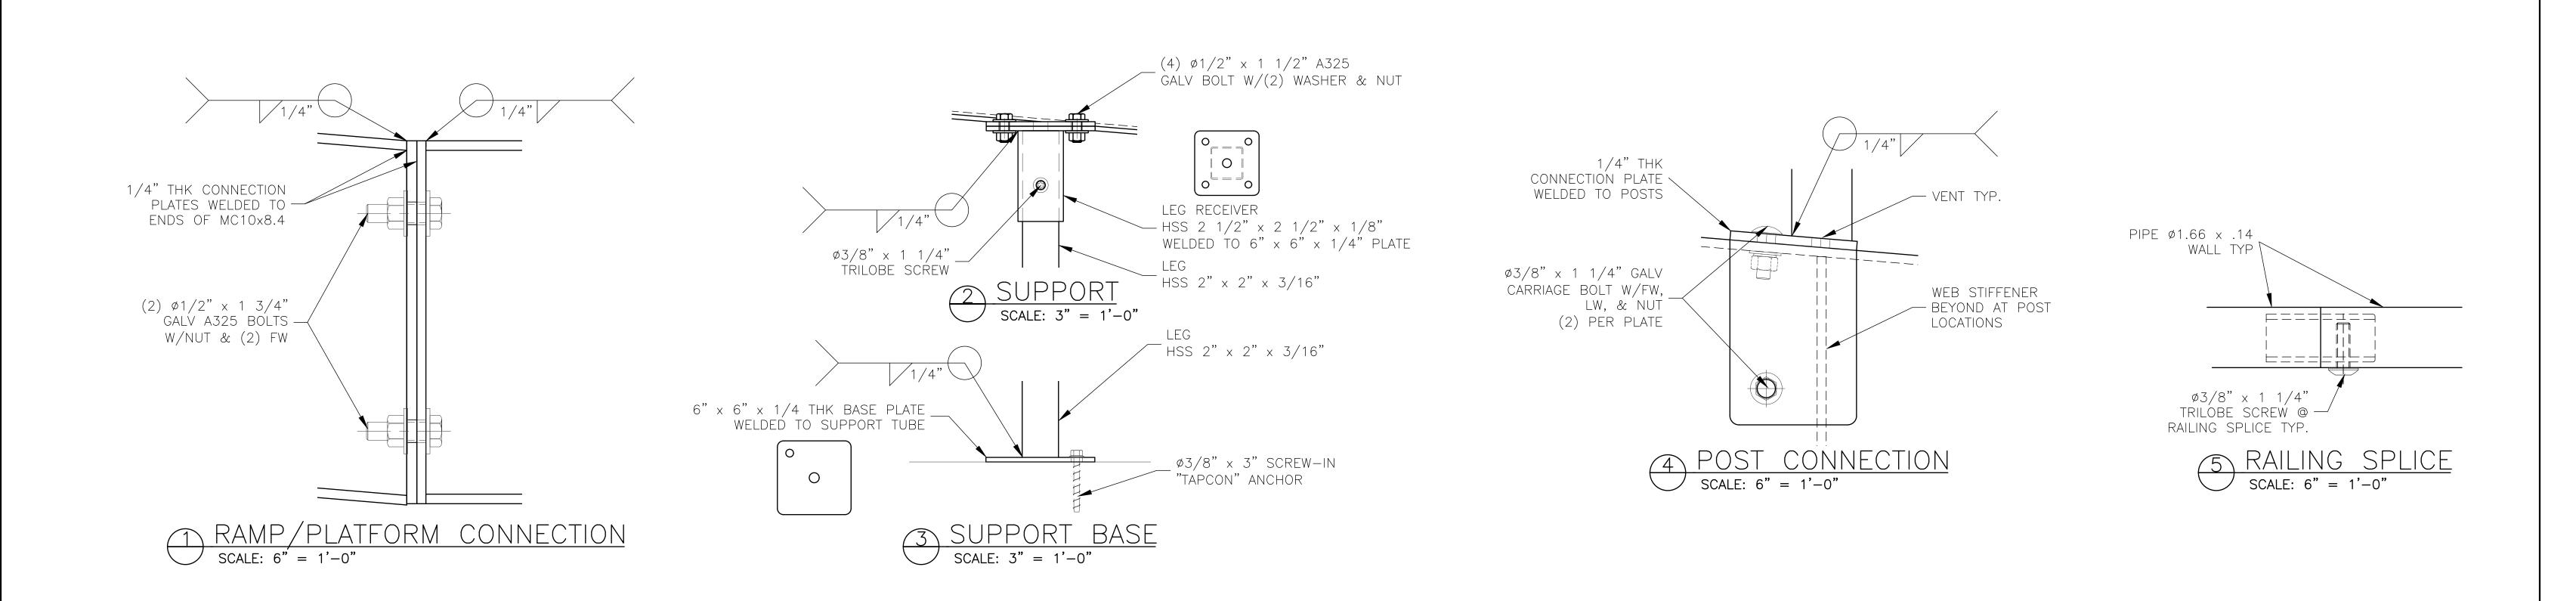



REV	DATE	DESCRIPTION	REV BY:	
0	11-17-20	ISSUED FOR STATE PLAN REVIEW	ALR	

<b>WINDUSTRIES</b> inc.					
CITY OF WEST BEIND REGINER PARK					
CITY OF WEST BEIND REGINER PARK					
CITY OF WEST BEIND REGINER PARK					
CITY OF WEST BEIND REGINER PARK					
CIT OF WEST BEIND REGINER PARK					
CITY OF WEST BEIND REGINER PARK					
CITY OF WEST BEIND REGINER PARK					
CITY OF WEST BEIND REGINER PARK					
CITY OF WEST BEIND REGINER PARK					
	CITY OF WEST BEIND REGNER PARK				
CARL KUSS FIELD DASEDALL FACILITI					
5662 Glendale Ave.       CLIENT:       WEST BEND BASEBALL ASSOCIATION         Green Bay, WI 54313       Oncl. Engineering					
(920) 865-7707 Fax (920) 865-7777	CIVIL ENGINEER: QUAM ENGINEERING, LLC				
jwoffice@jwindustriesinc.com SITE CONTRACTORH&H CIVIL CONSTRUCTION, LLC					
"We provide everything except the spectators." JOB#: 20311 DATE: 11-17-20 DRAWN BY: ALR SHEET 2					

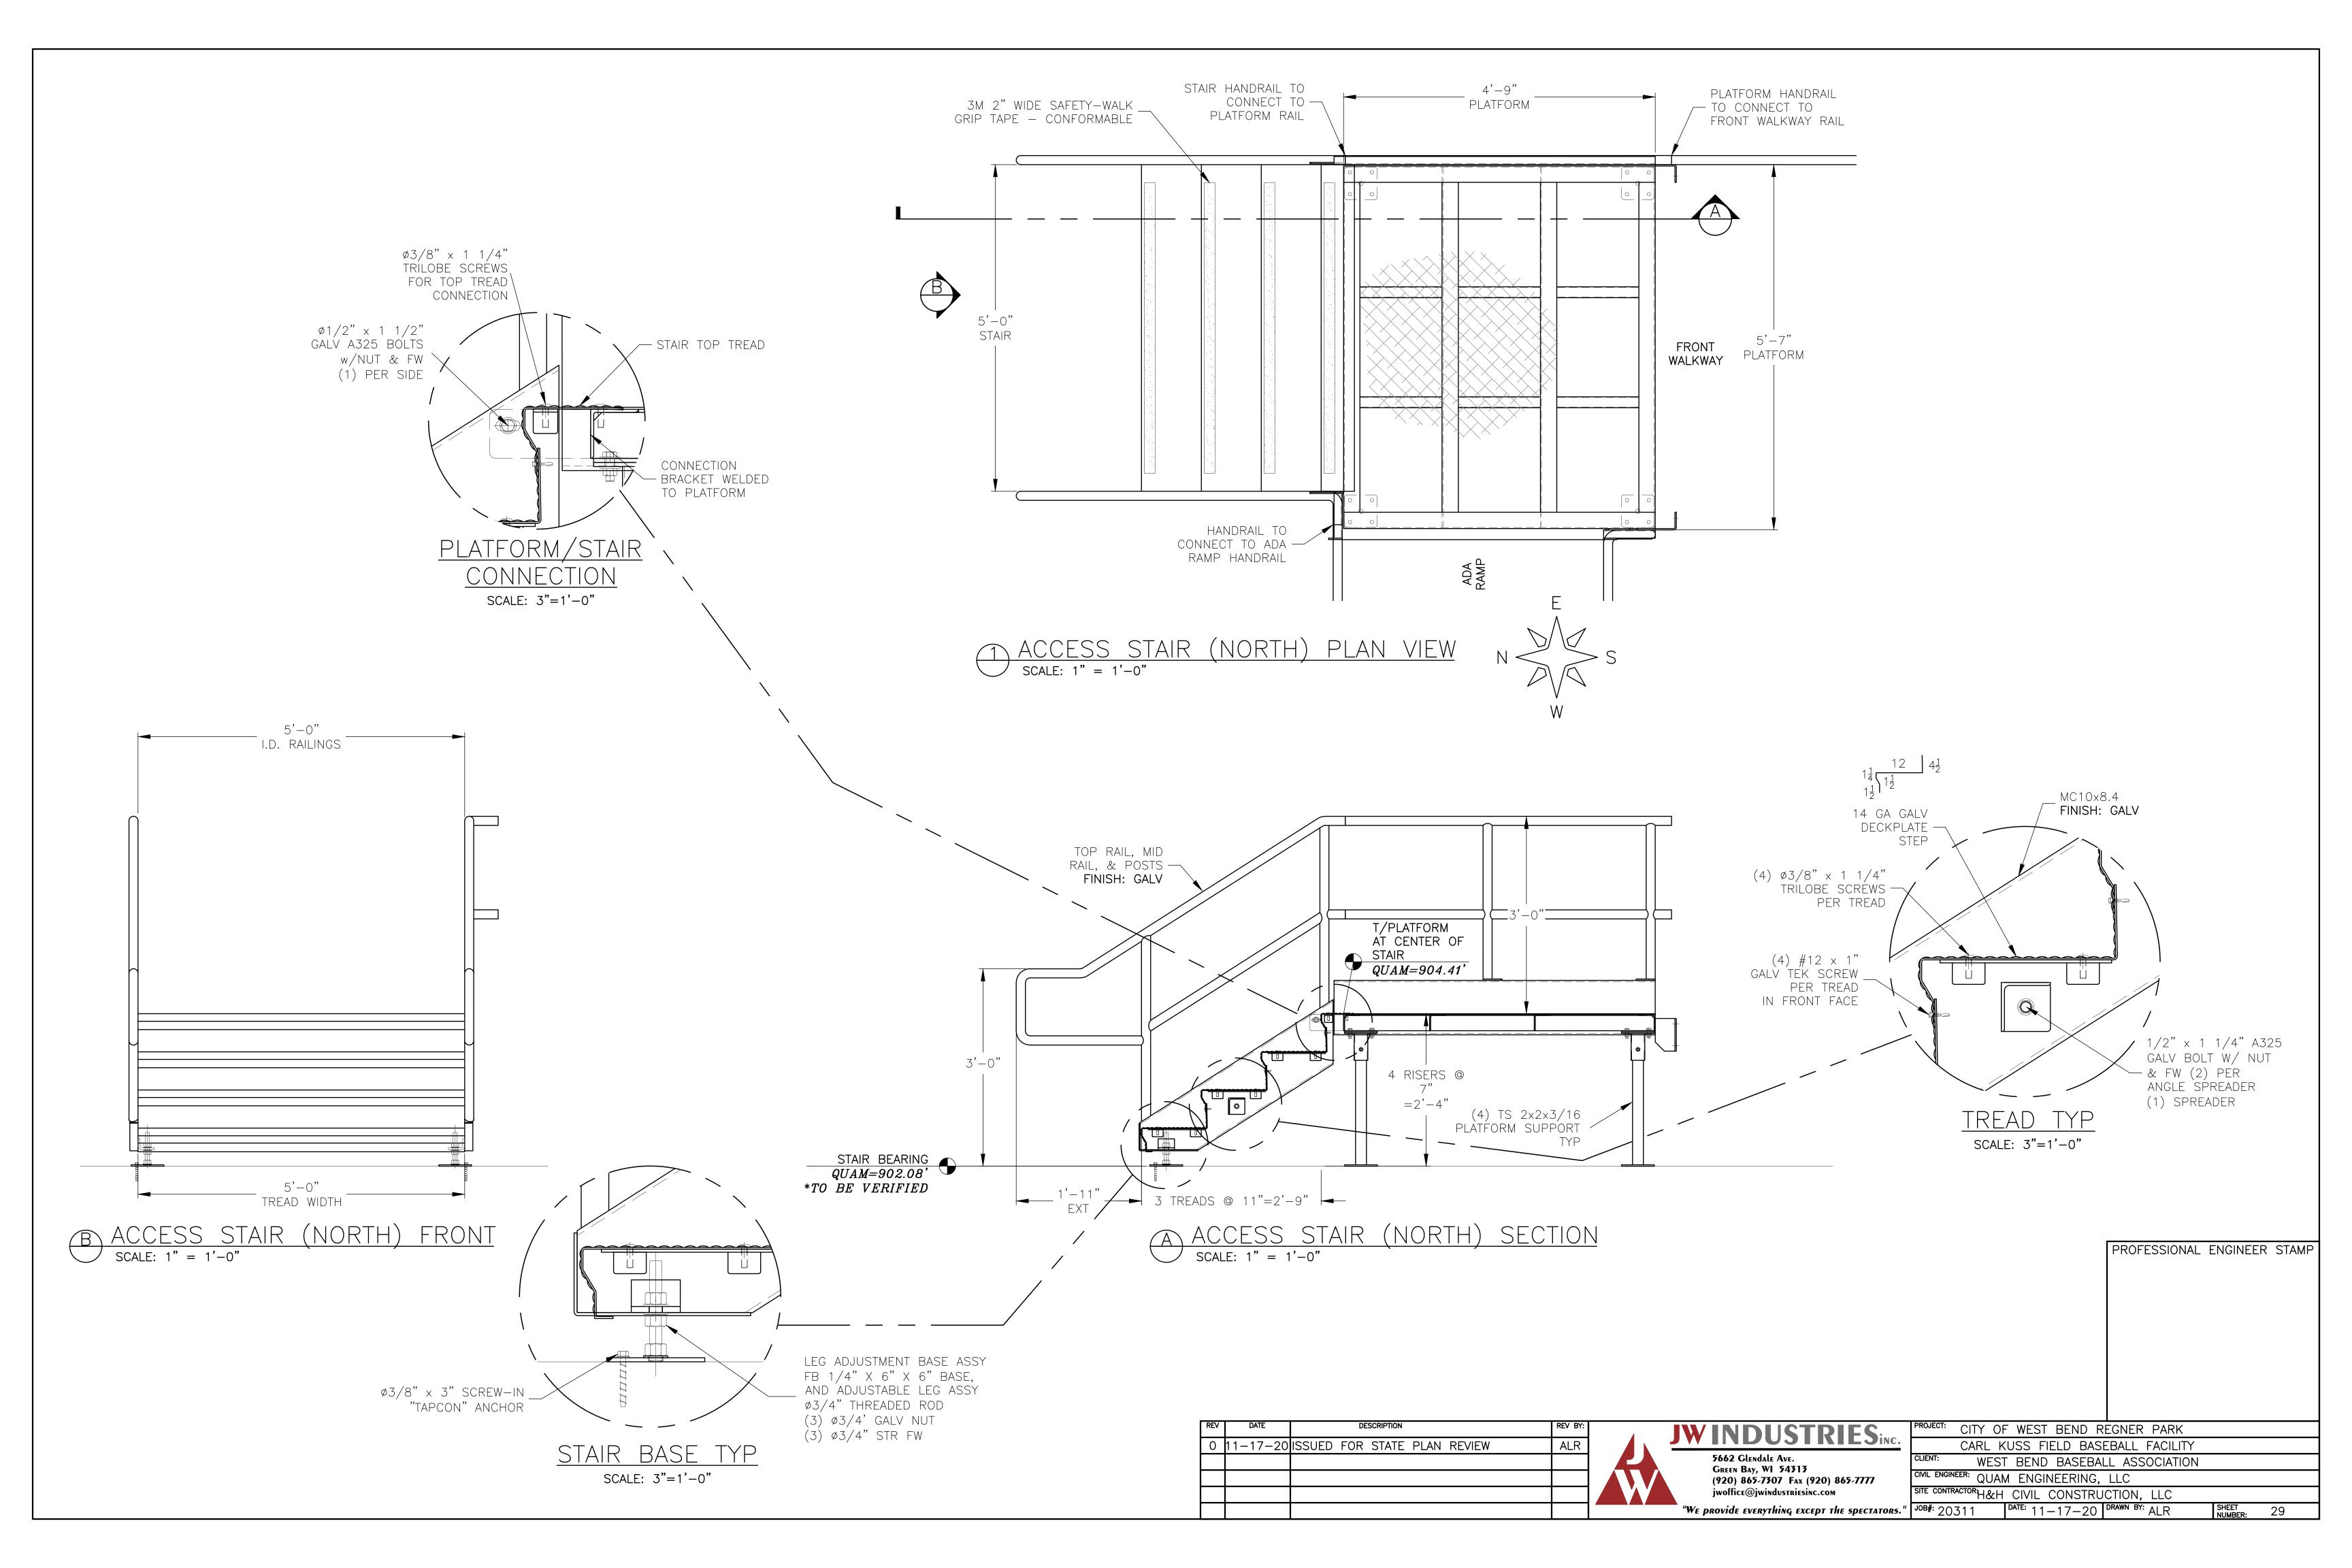


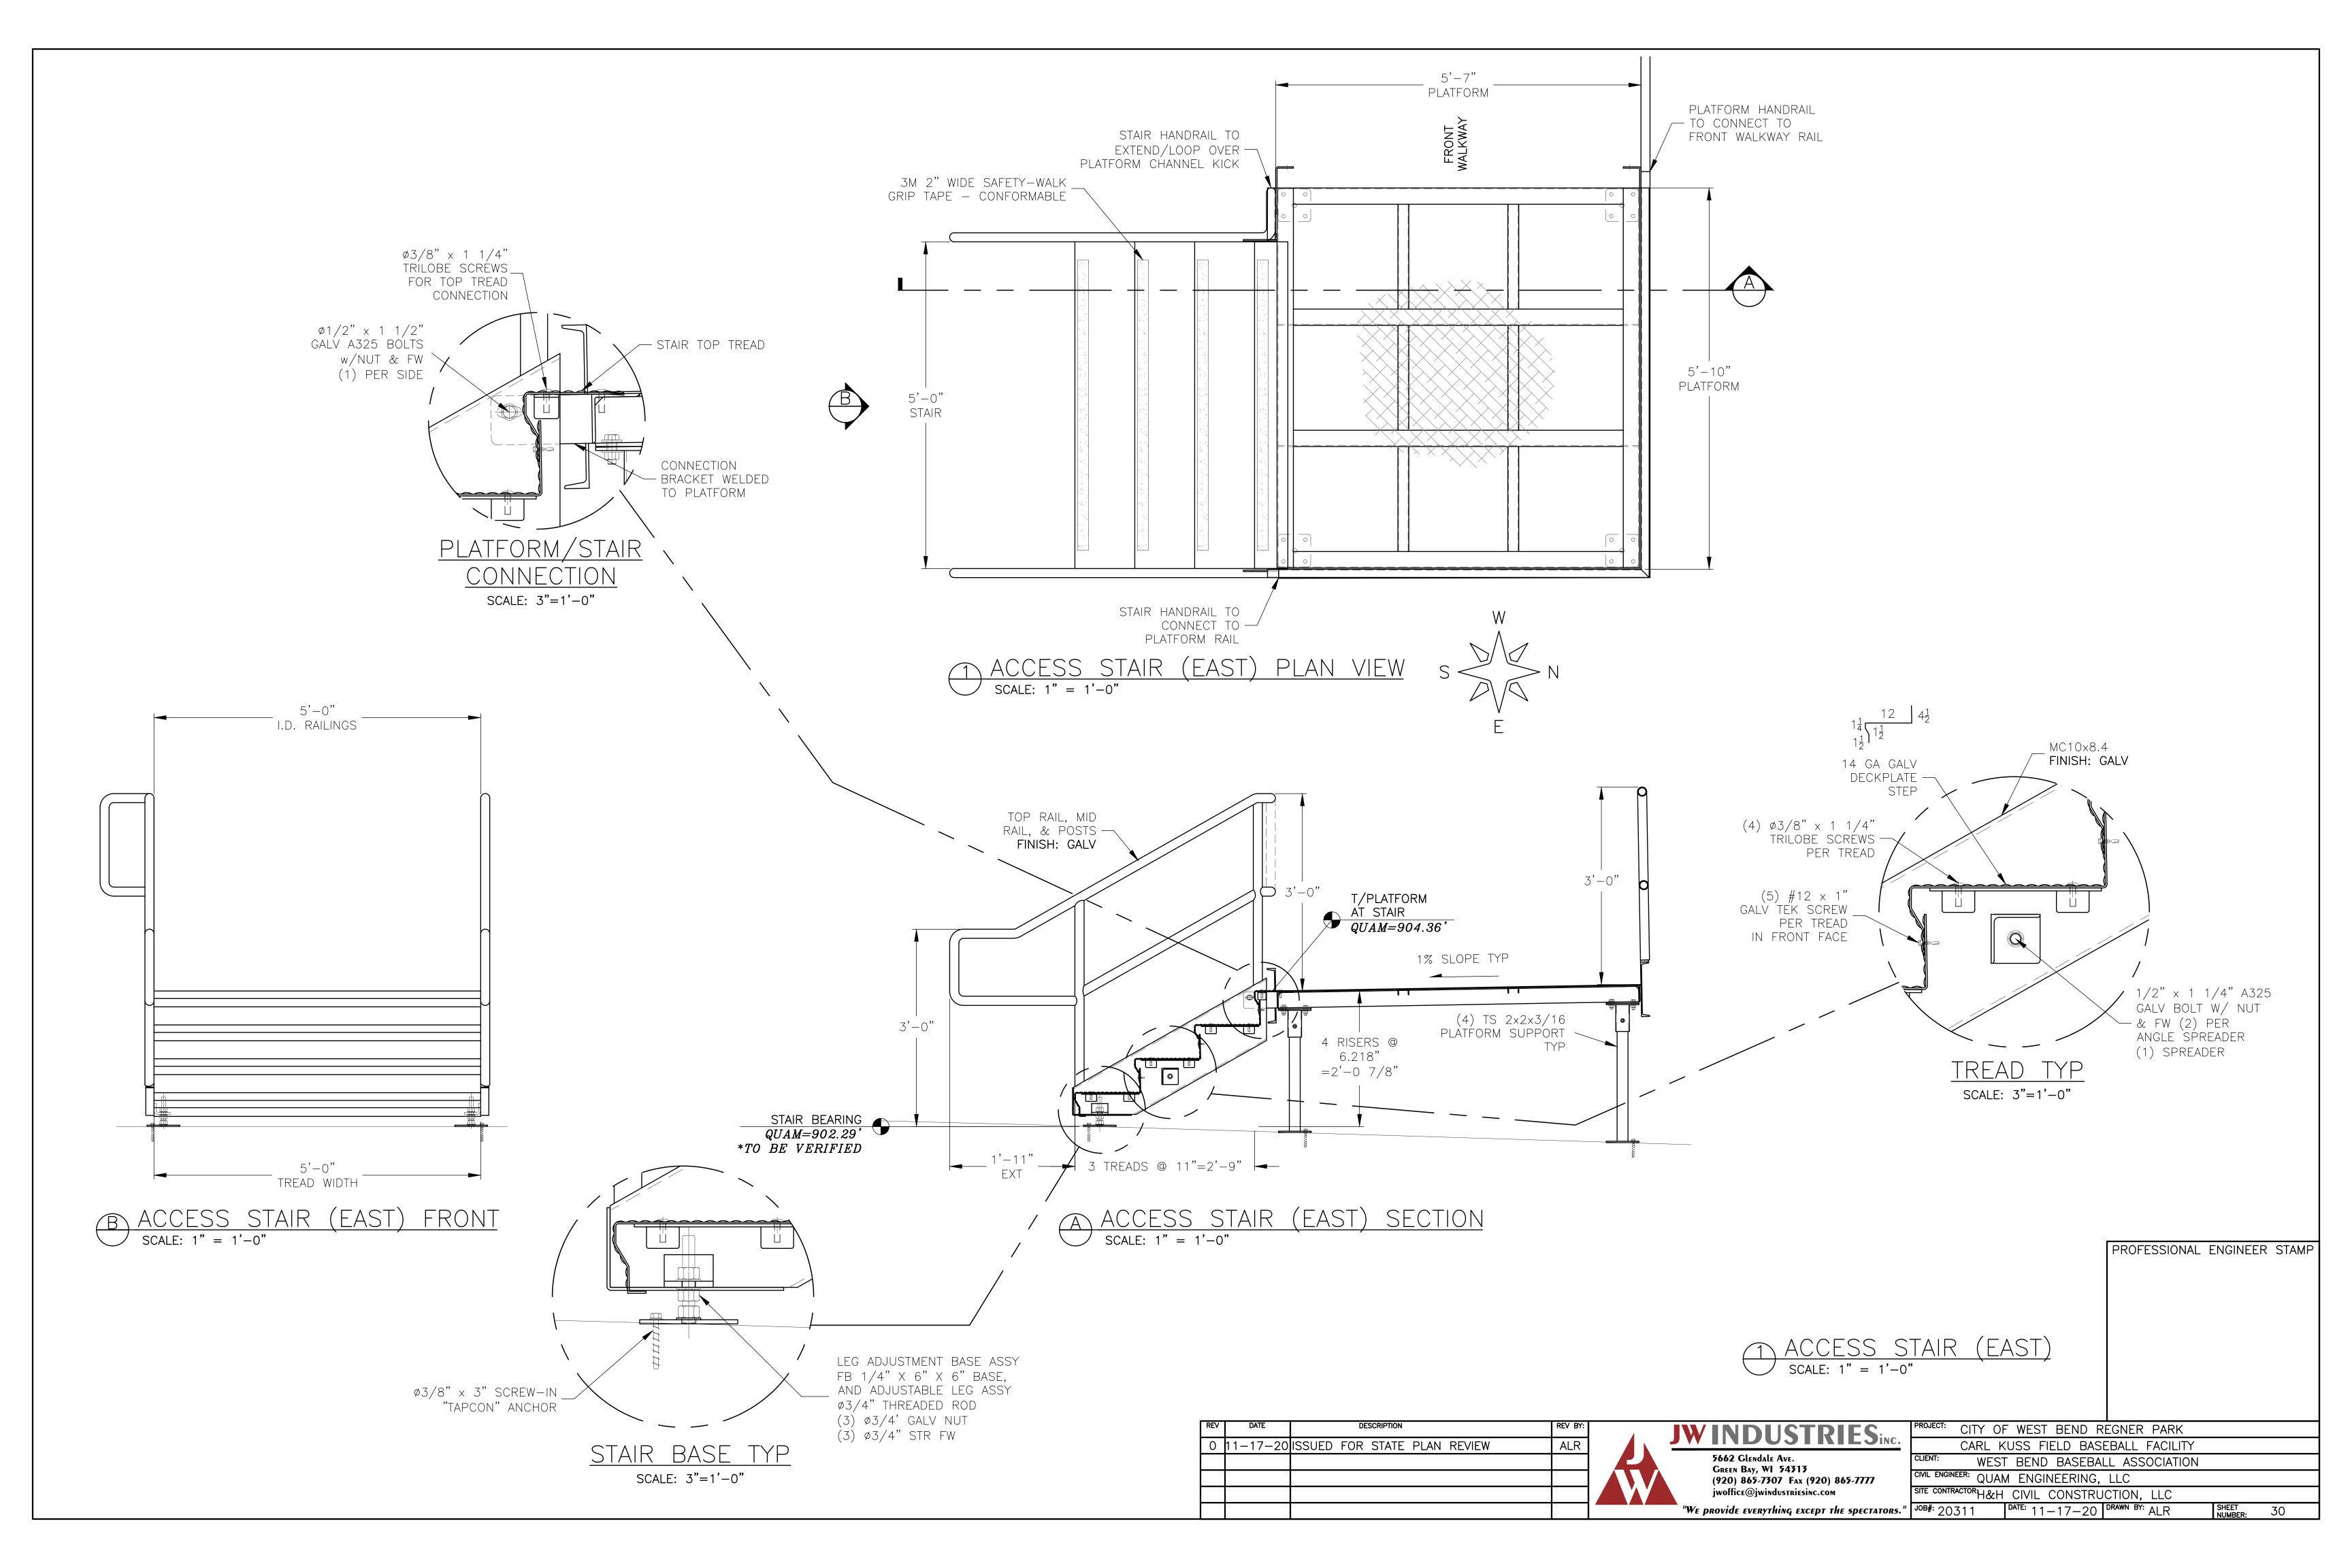

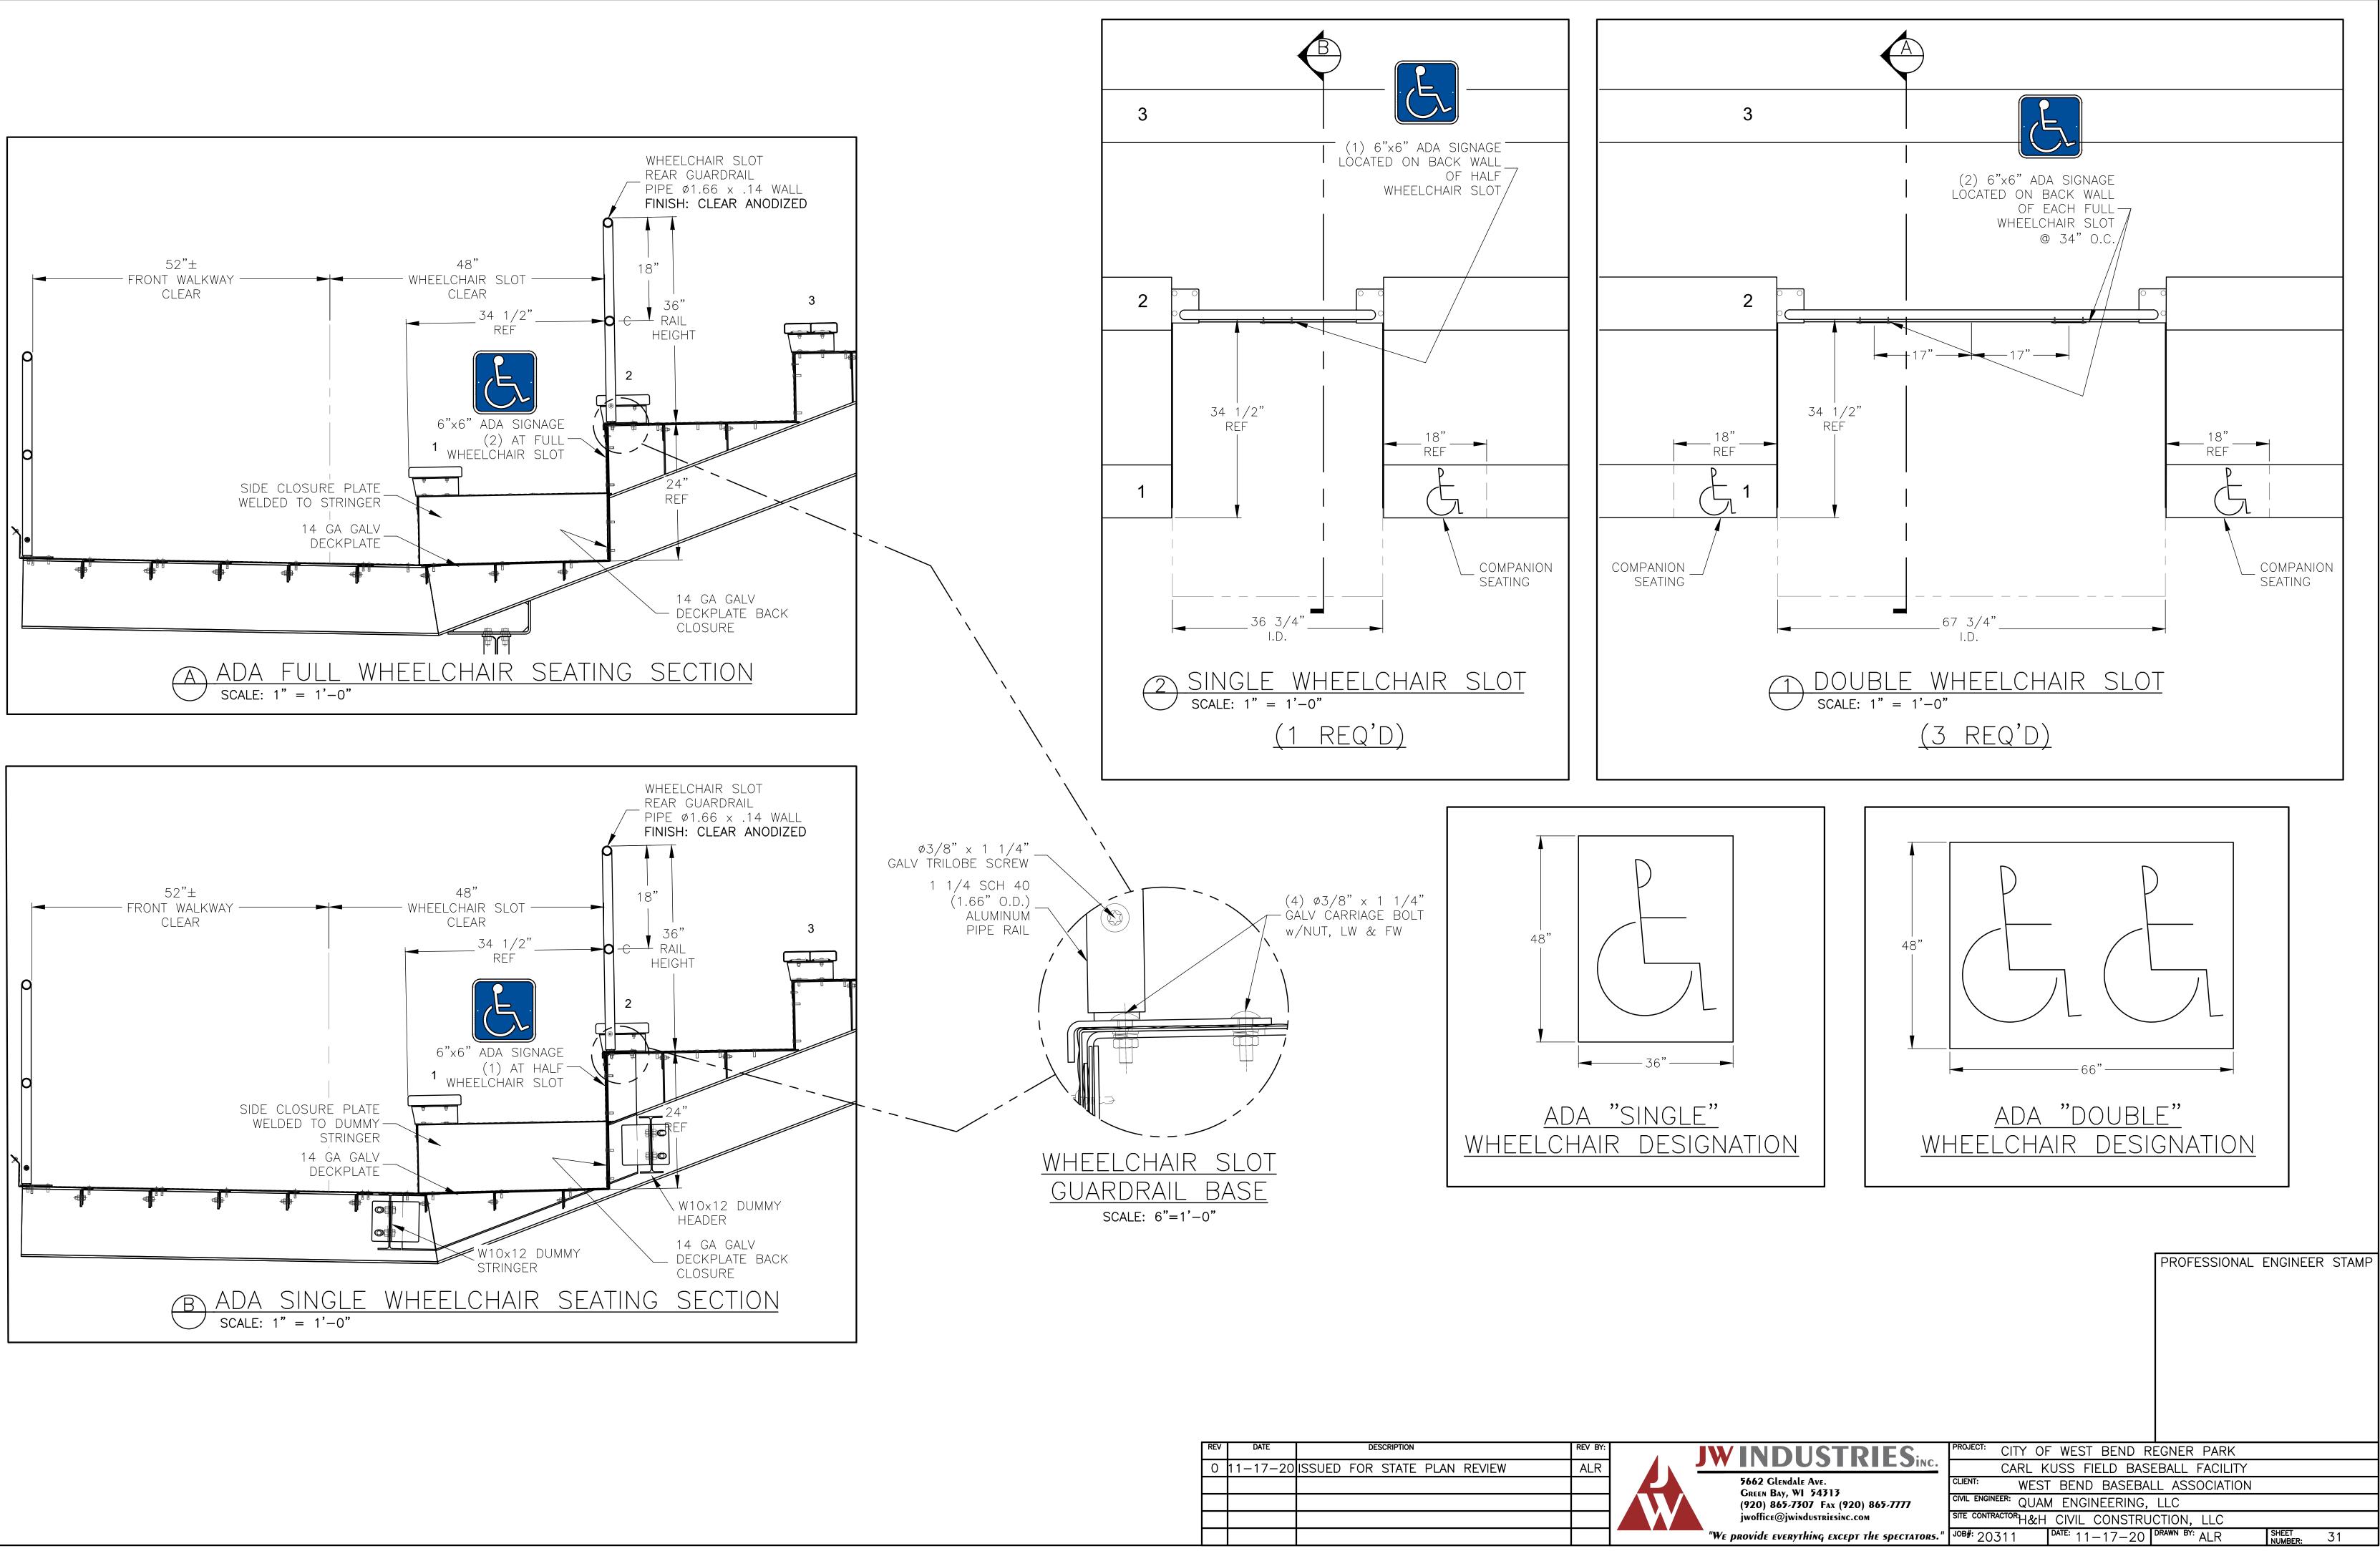


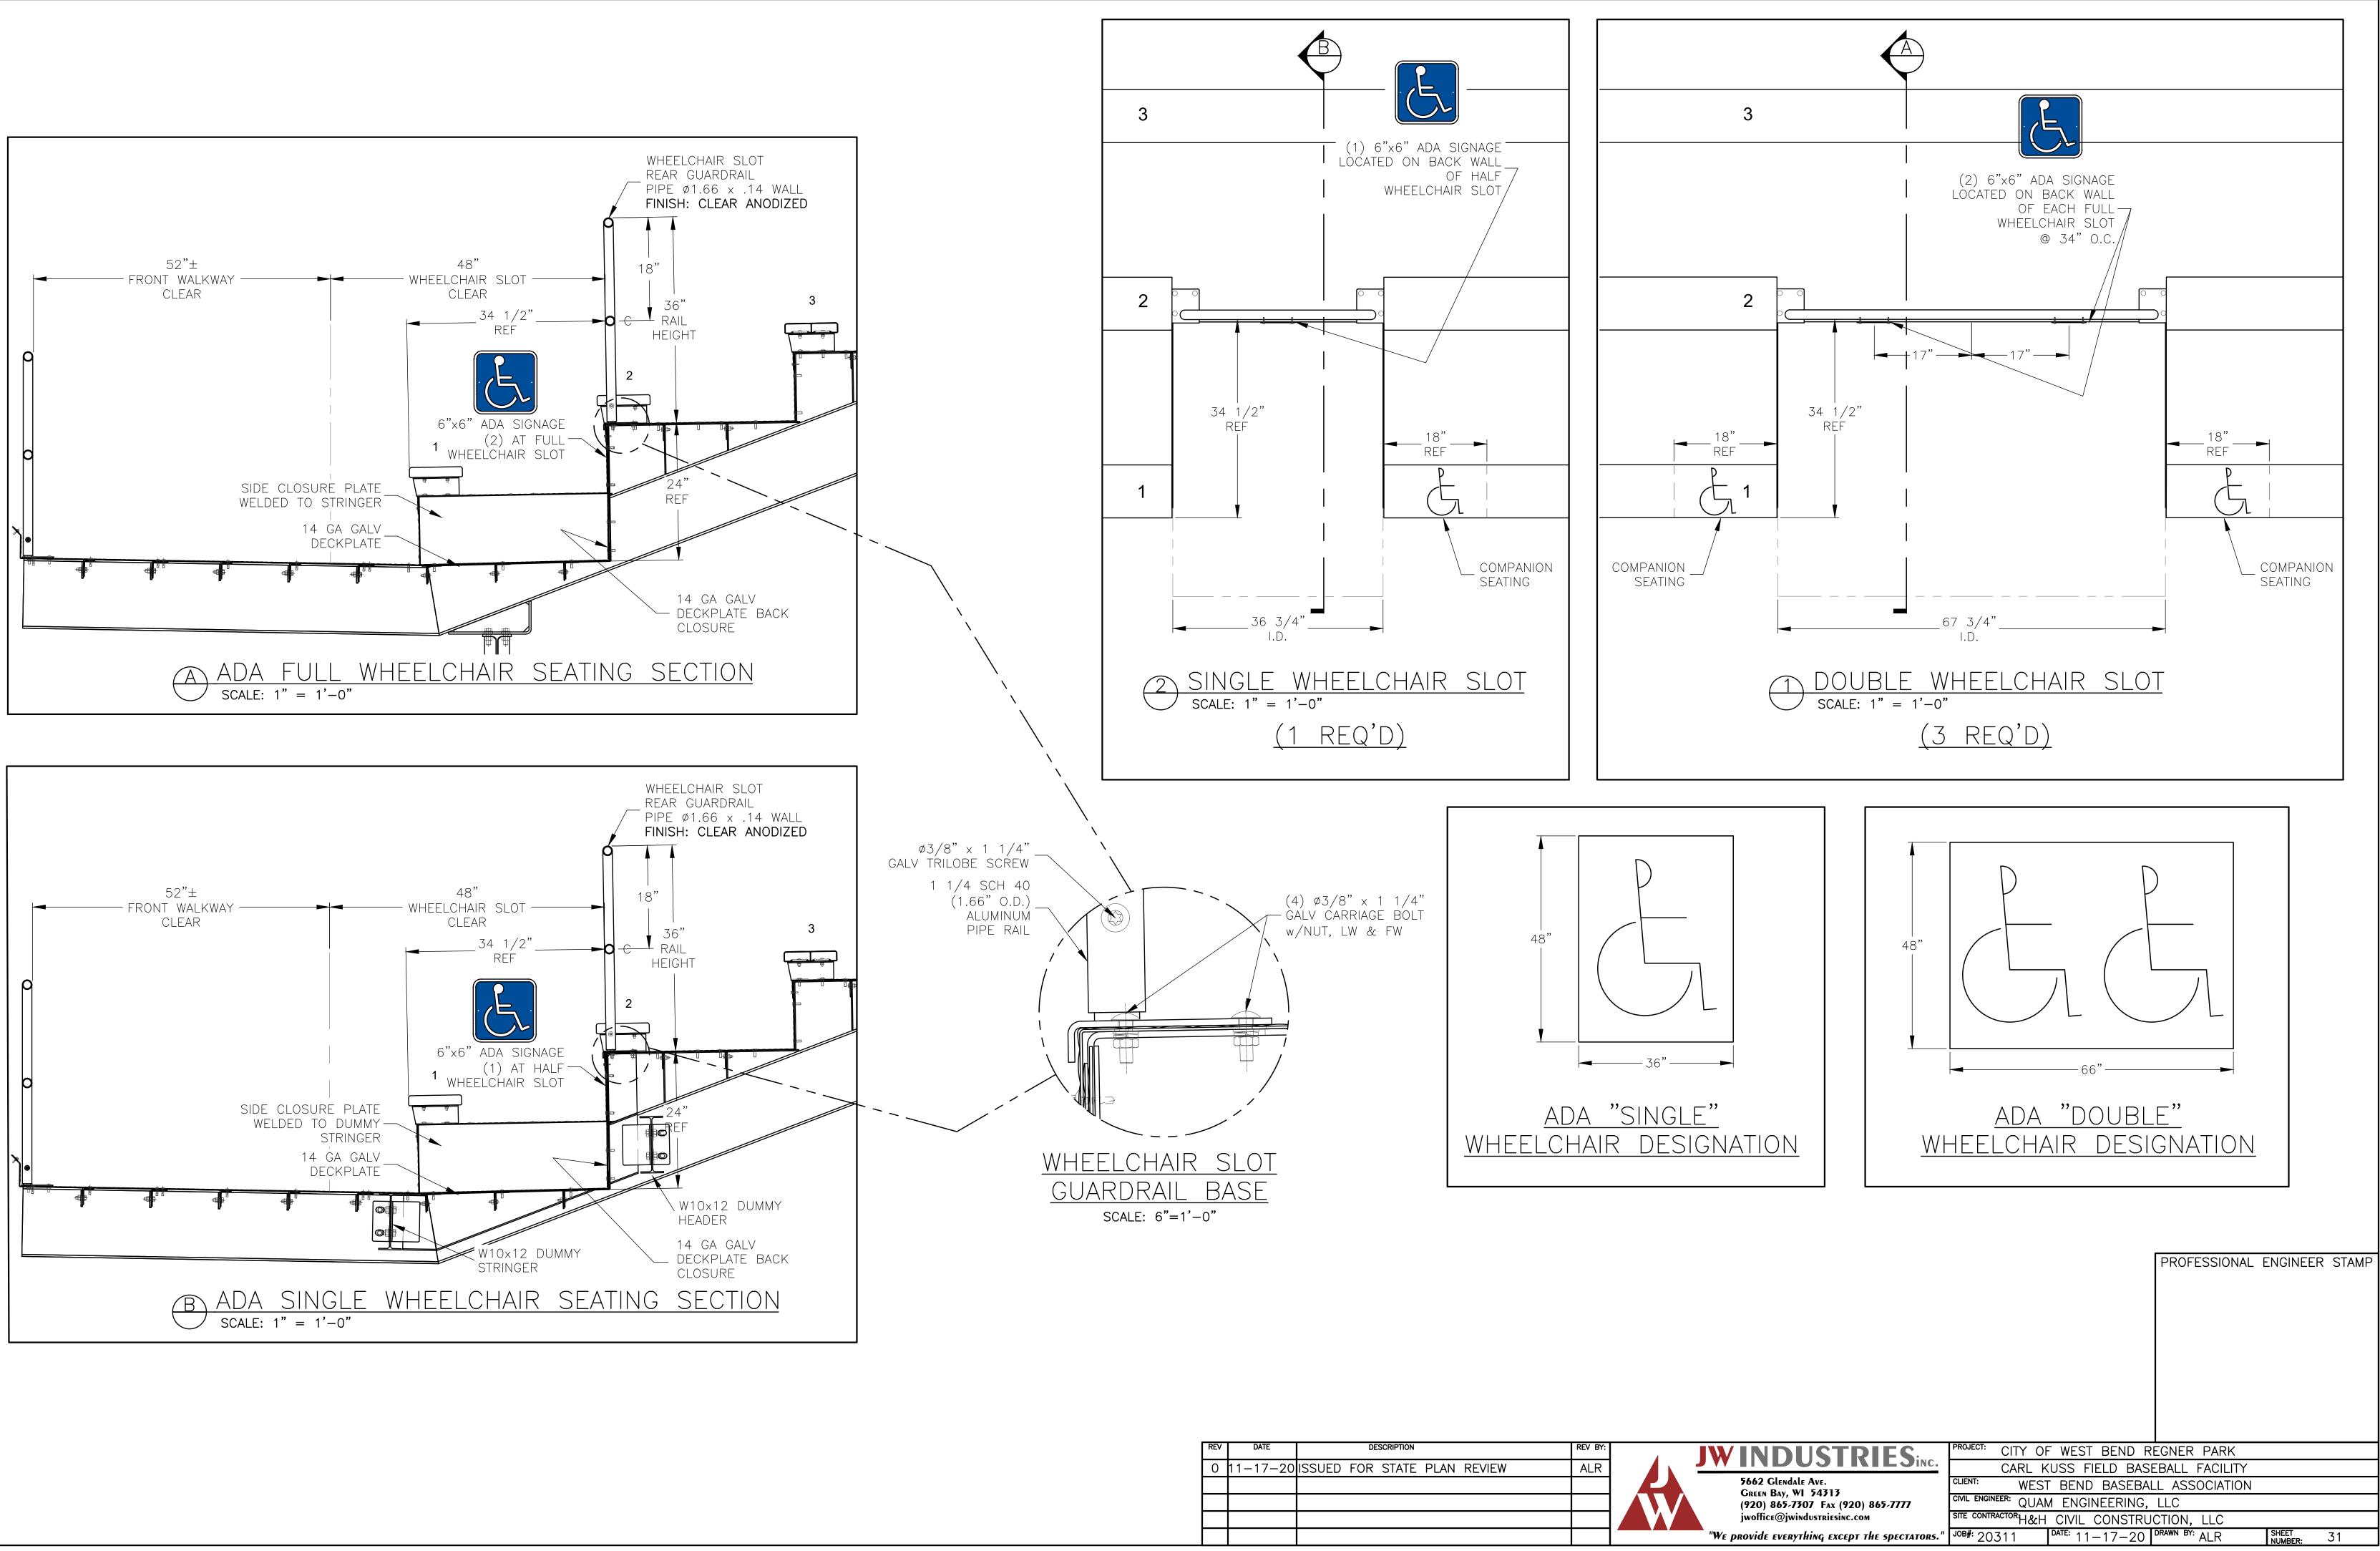


REV	DATE	DESCRIPTION		REV BY:	
0	11-17-20	SSUED FOR STATE	PLAN REVIEW	ALR	

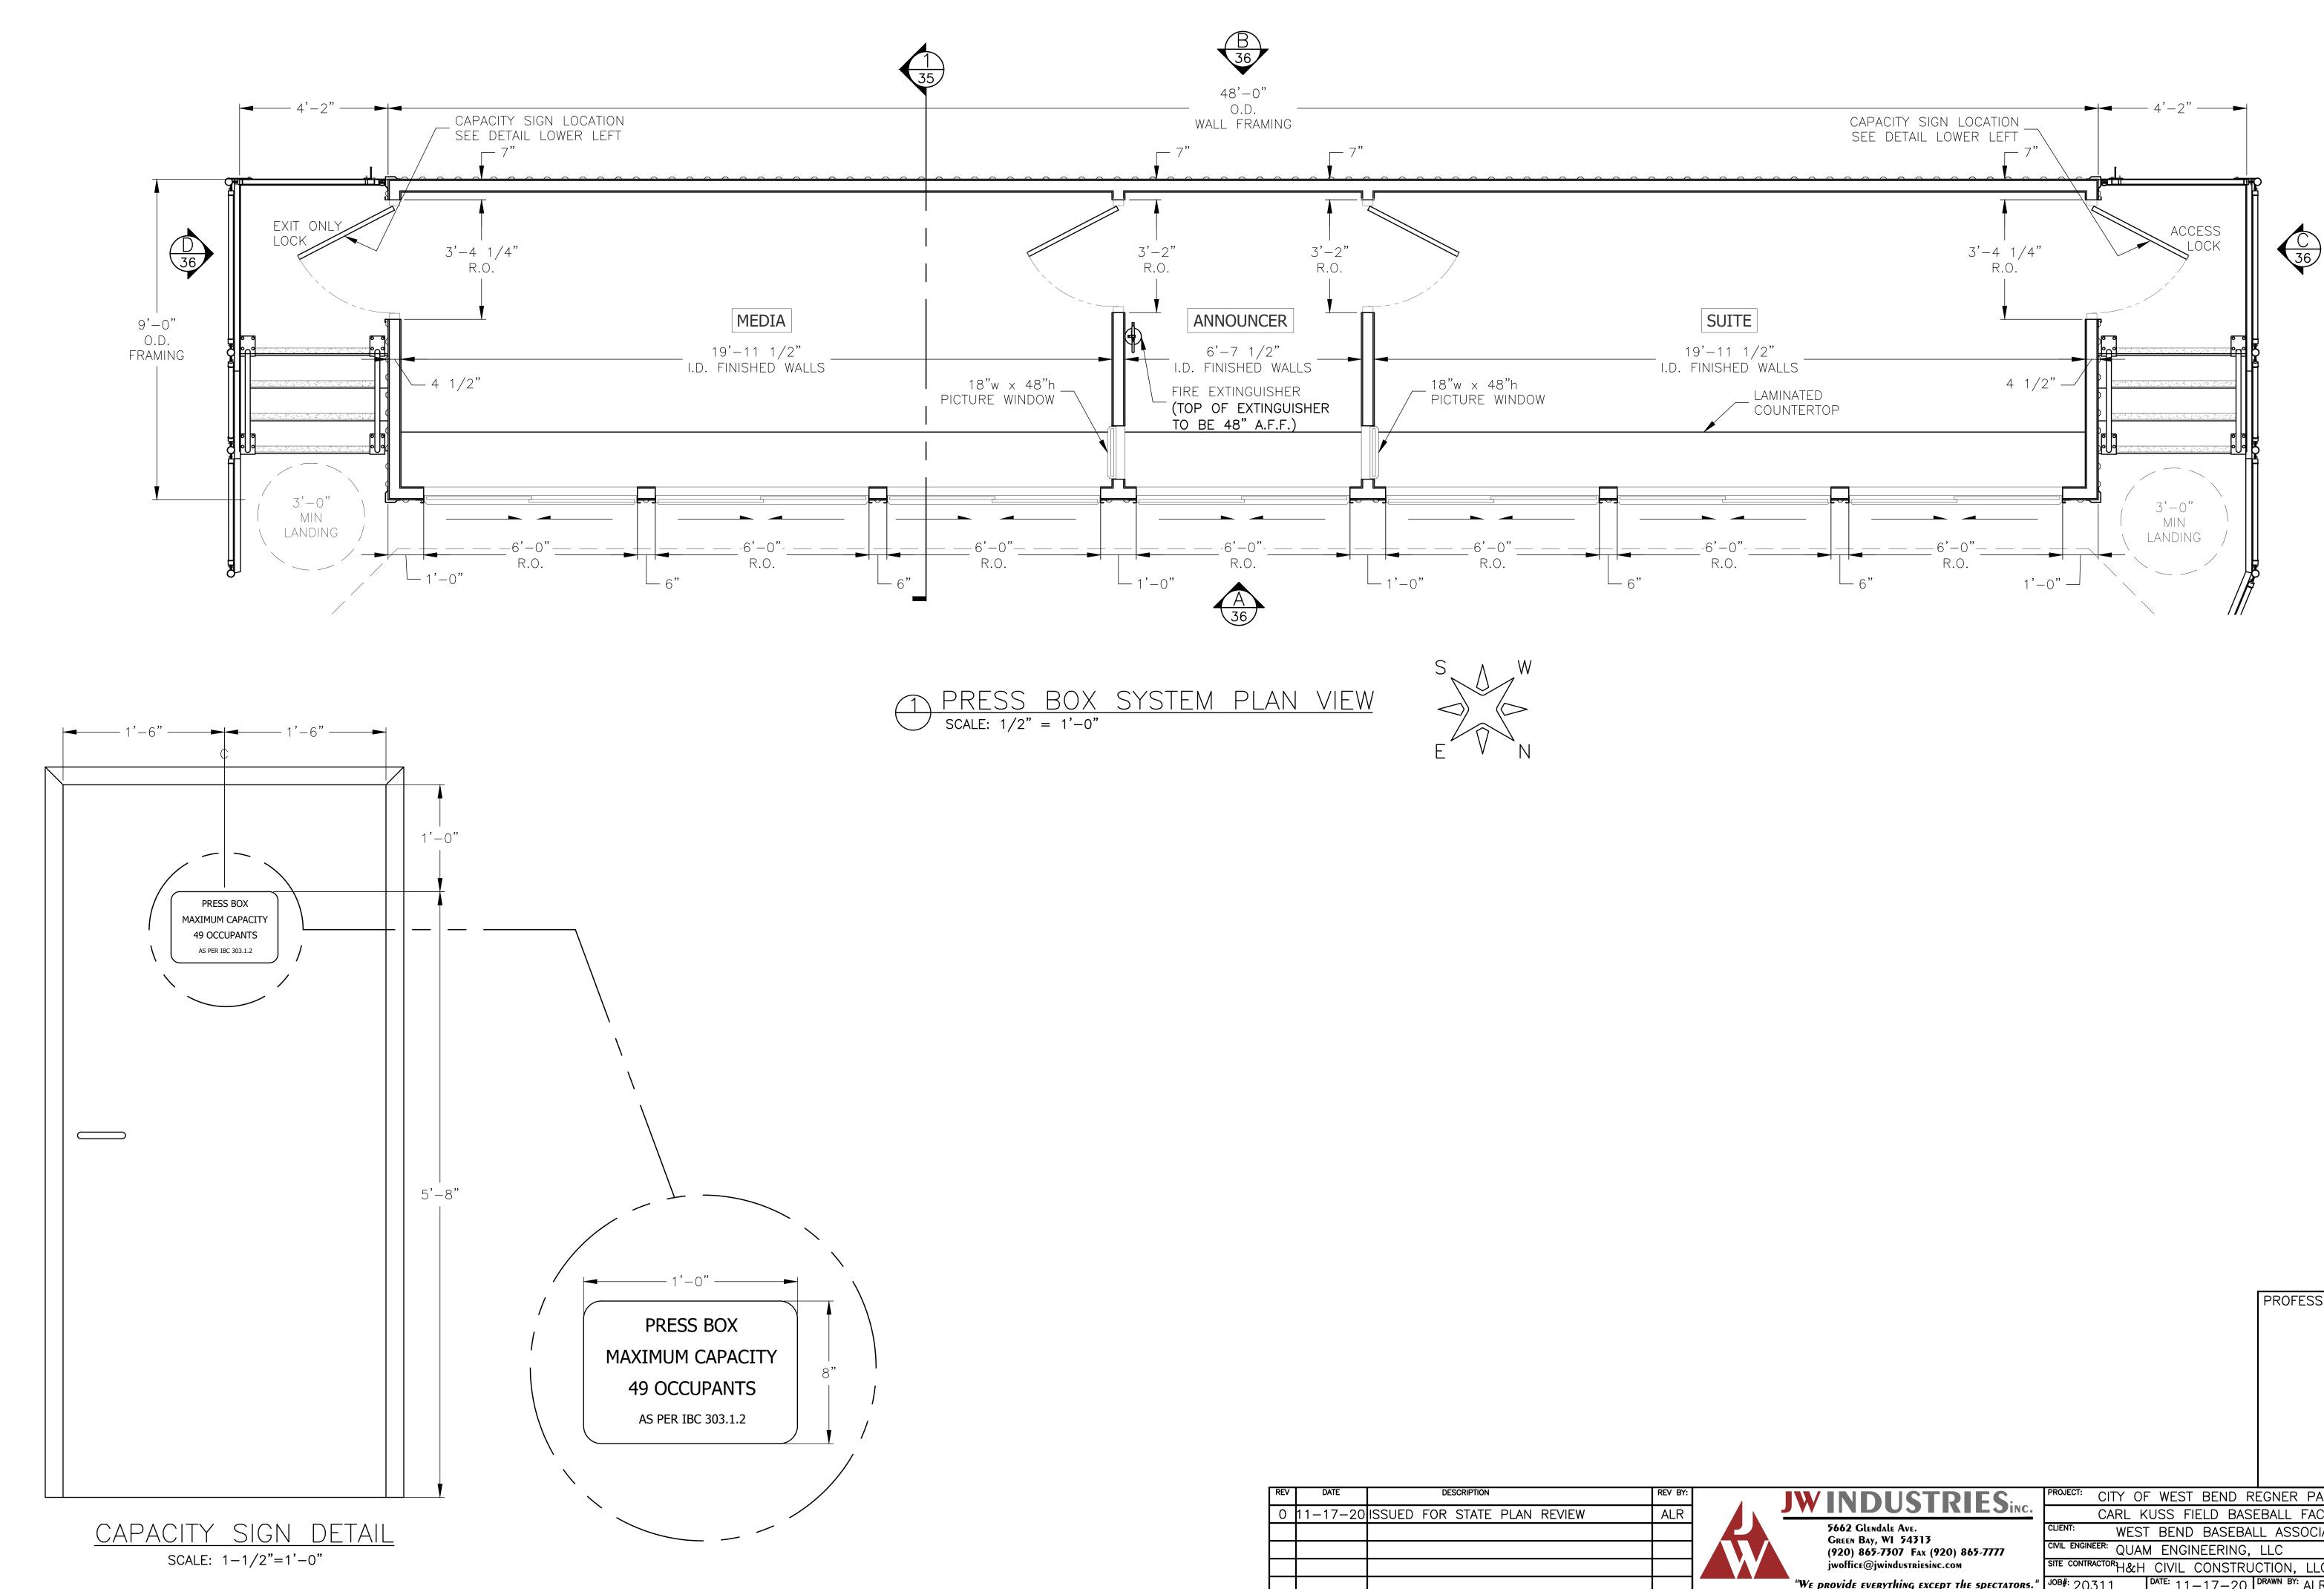



			PROFESSIONAL ENGINEER STAMP
REV DATE DESCRIPTION	REV BY:	<b>JWINDUSTRIES</b> inc.	PROJECT: CITY OF WEST BEND REGNER PARK
0 11-17-20 ISSUED FOR STATE PLAN REVIEW	ALR		CARL KUSS FIELD BASEBALL FACILITY
		5662 Glendale Ave.	CLIENT: WEST BEND BASEBALL ASSOCIATION
		Green Bay, WI 54313 (920) 865-7307 Fax (920) 865-7777	<sup>CIVIL ENGINEER:</sup> QUAM ENGINEERING, LLC
		jwoffice@jwindustriesinc.com	SITE CONTRACTOR H&H CIVIL CONSTRUCTION, LLC
		"We provide everything except the spectators."	JOB#: 20311 DATE: 11-17-20 DRAWN BY: ALR SHEET 32

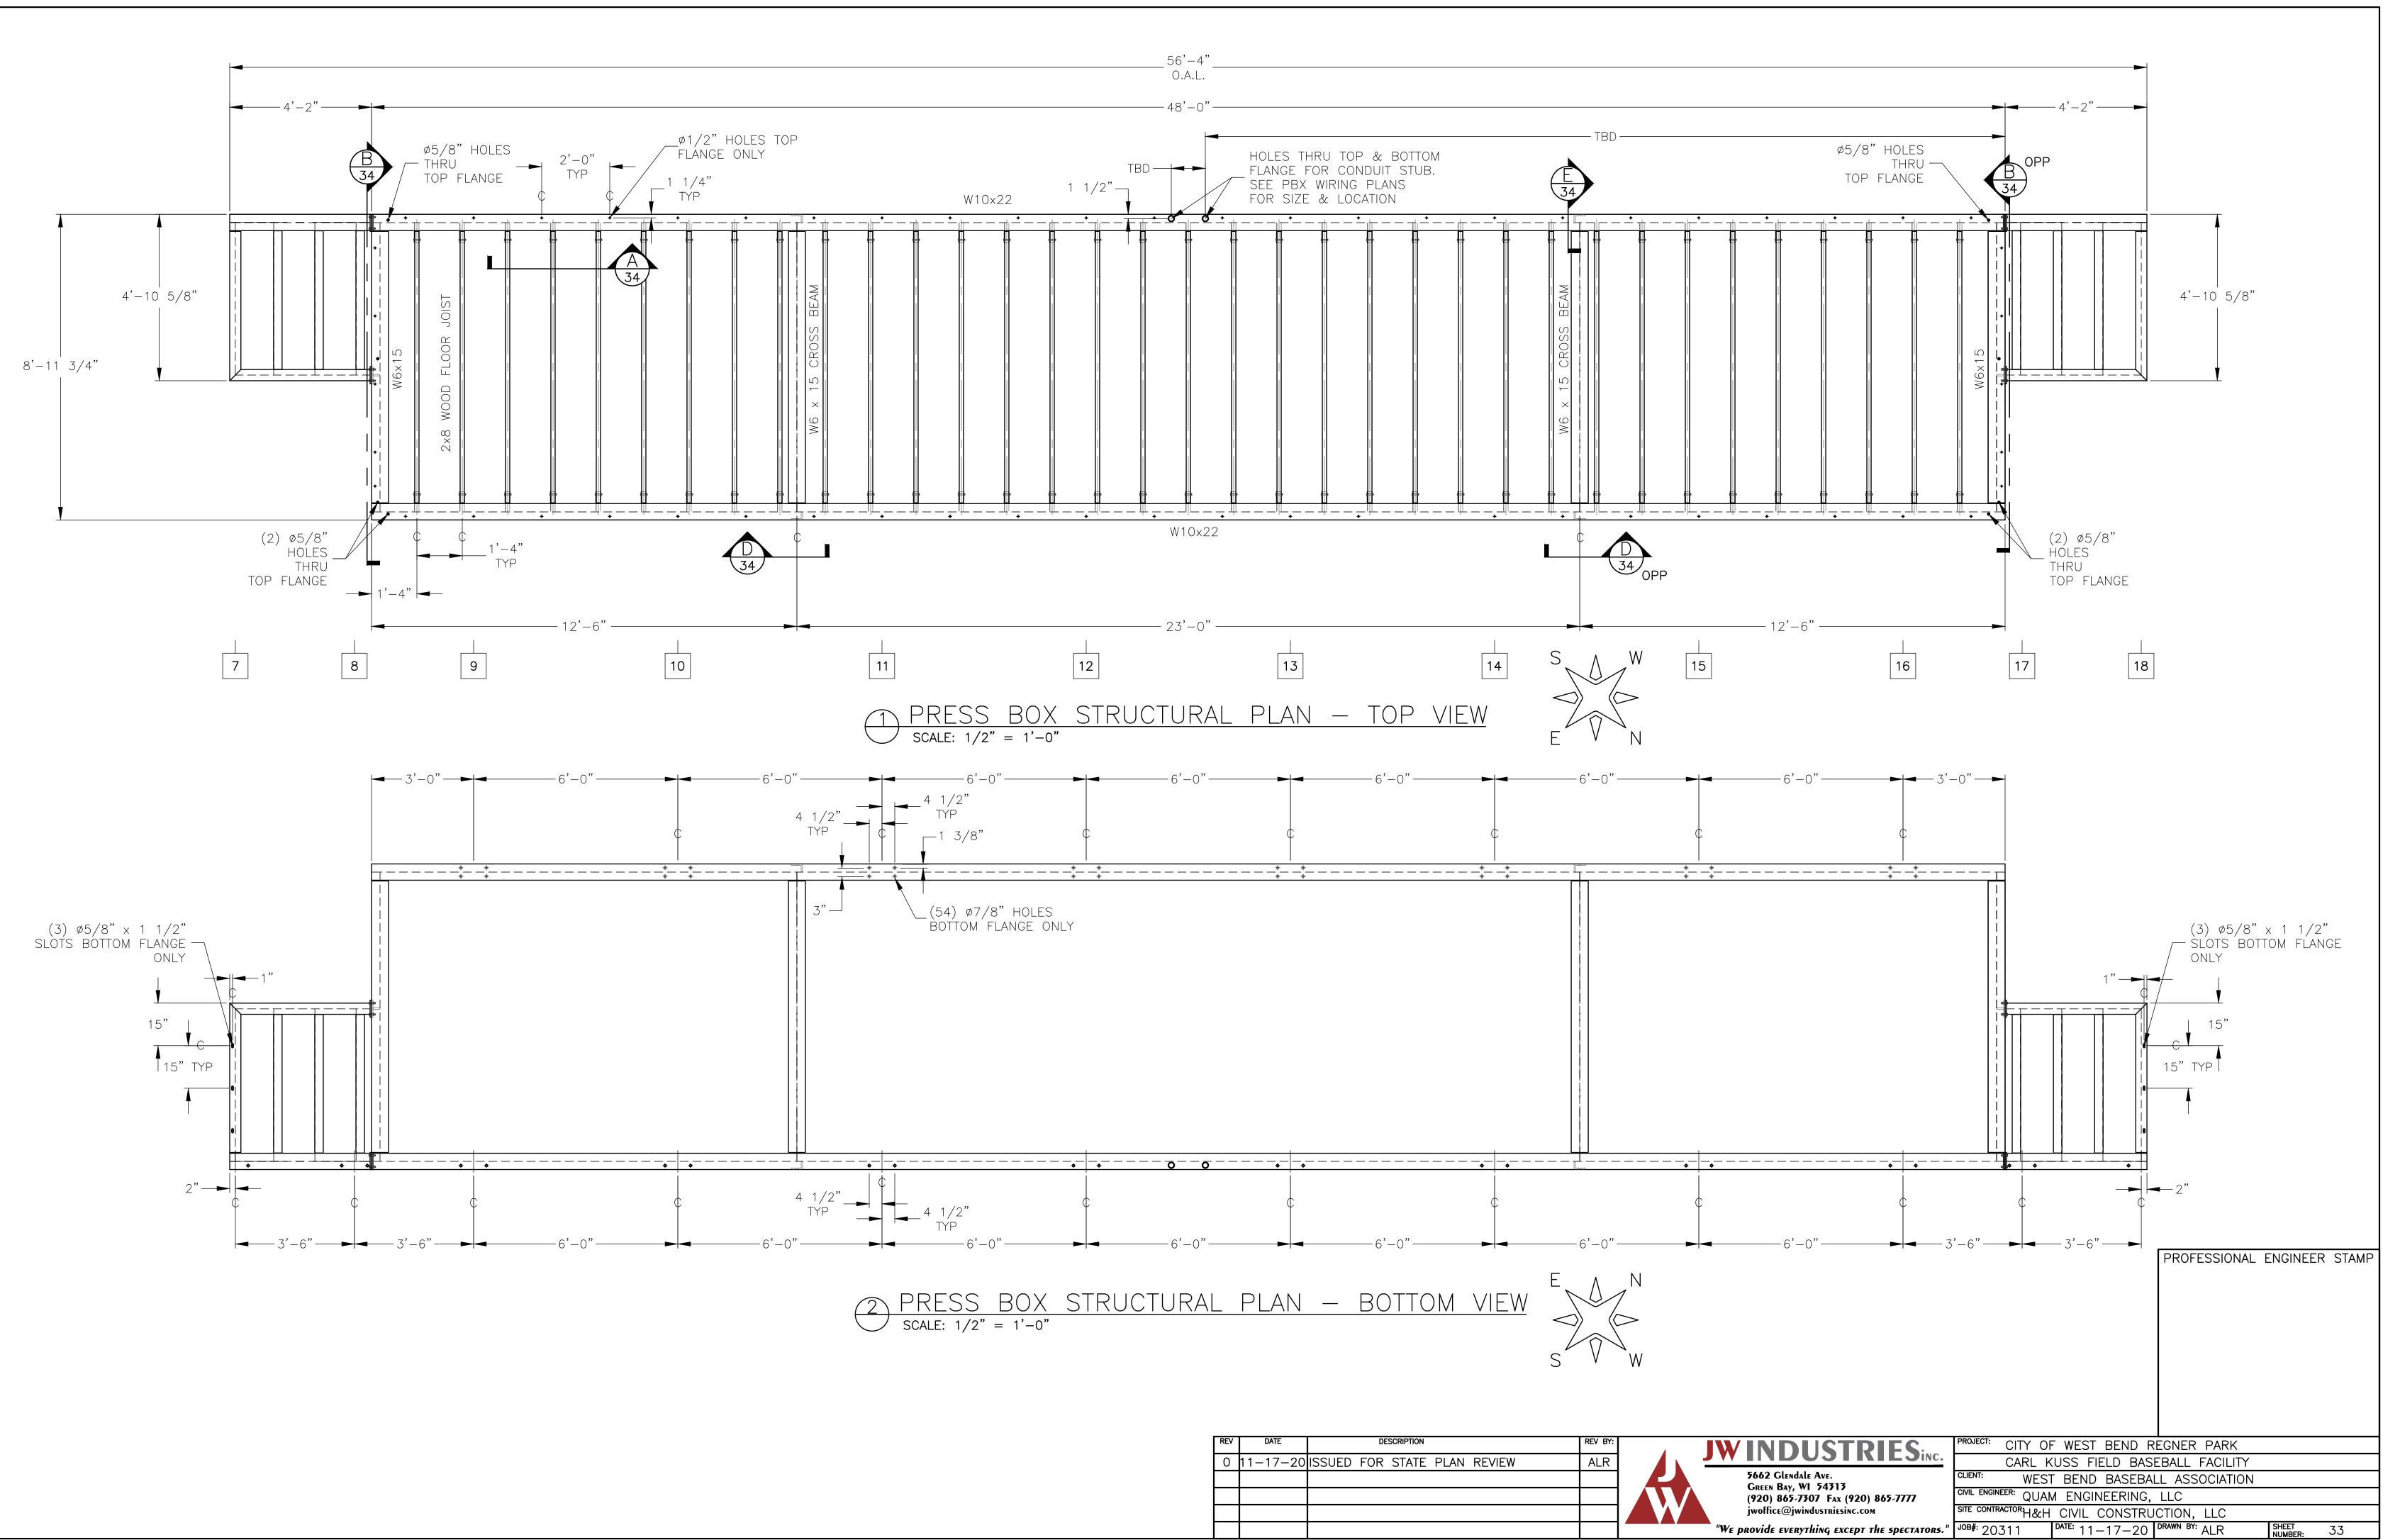


REV	DATE	DESCRIPTION	REV BY:	
0	11-17-20	ISSUED FOR STATE PLAN REVIEW	ALR	

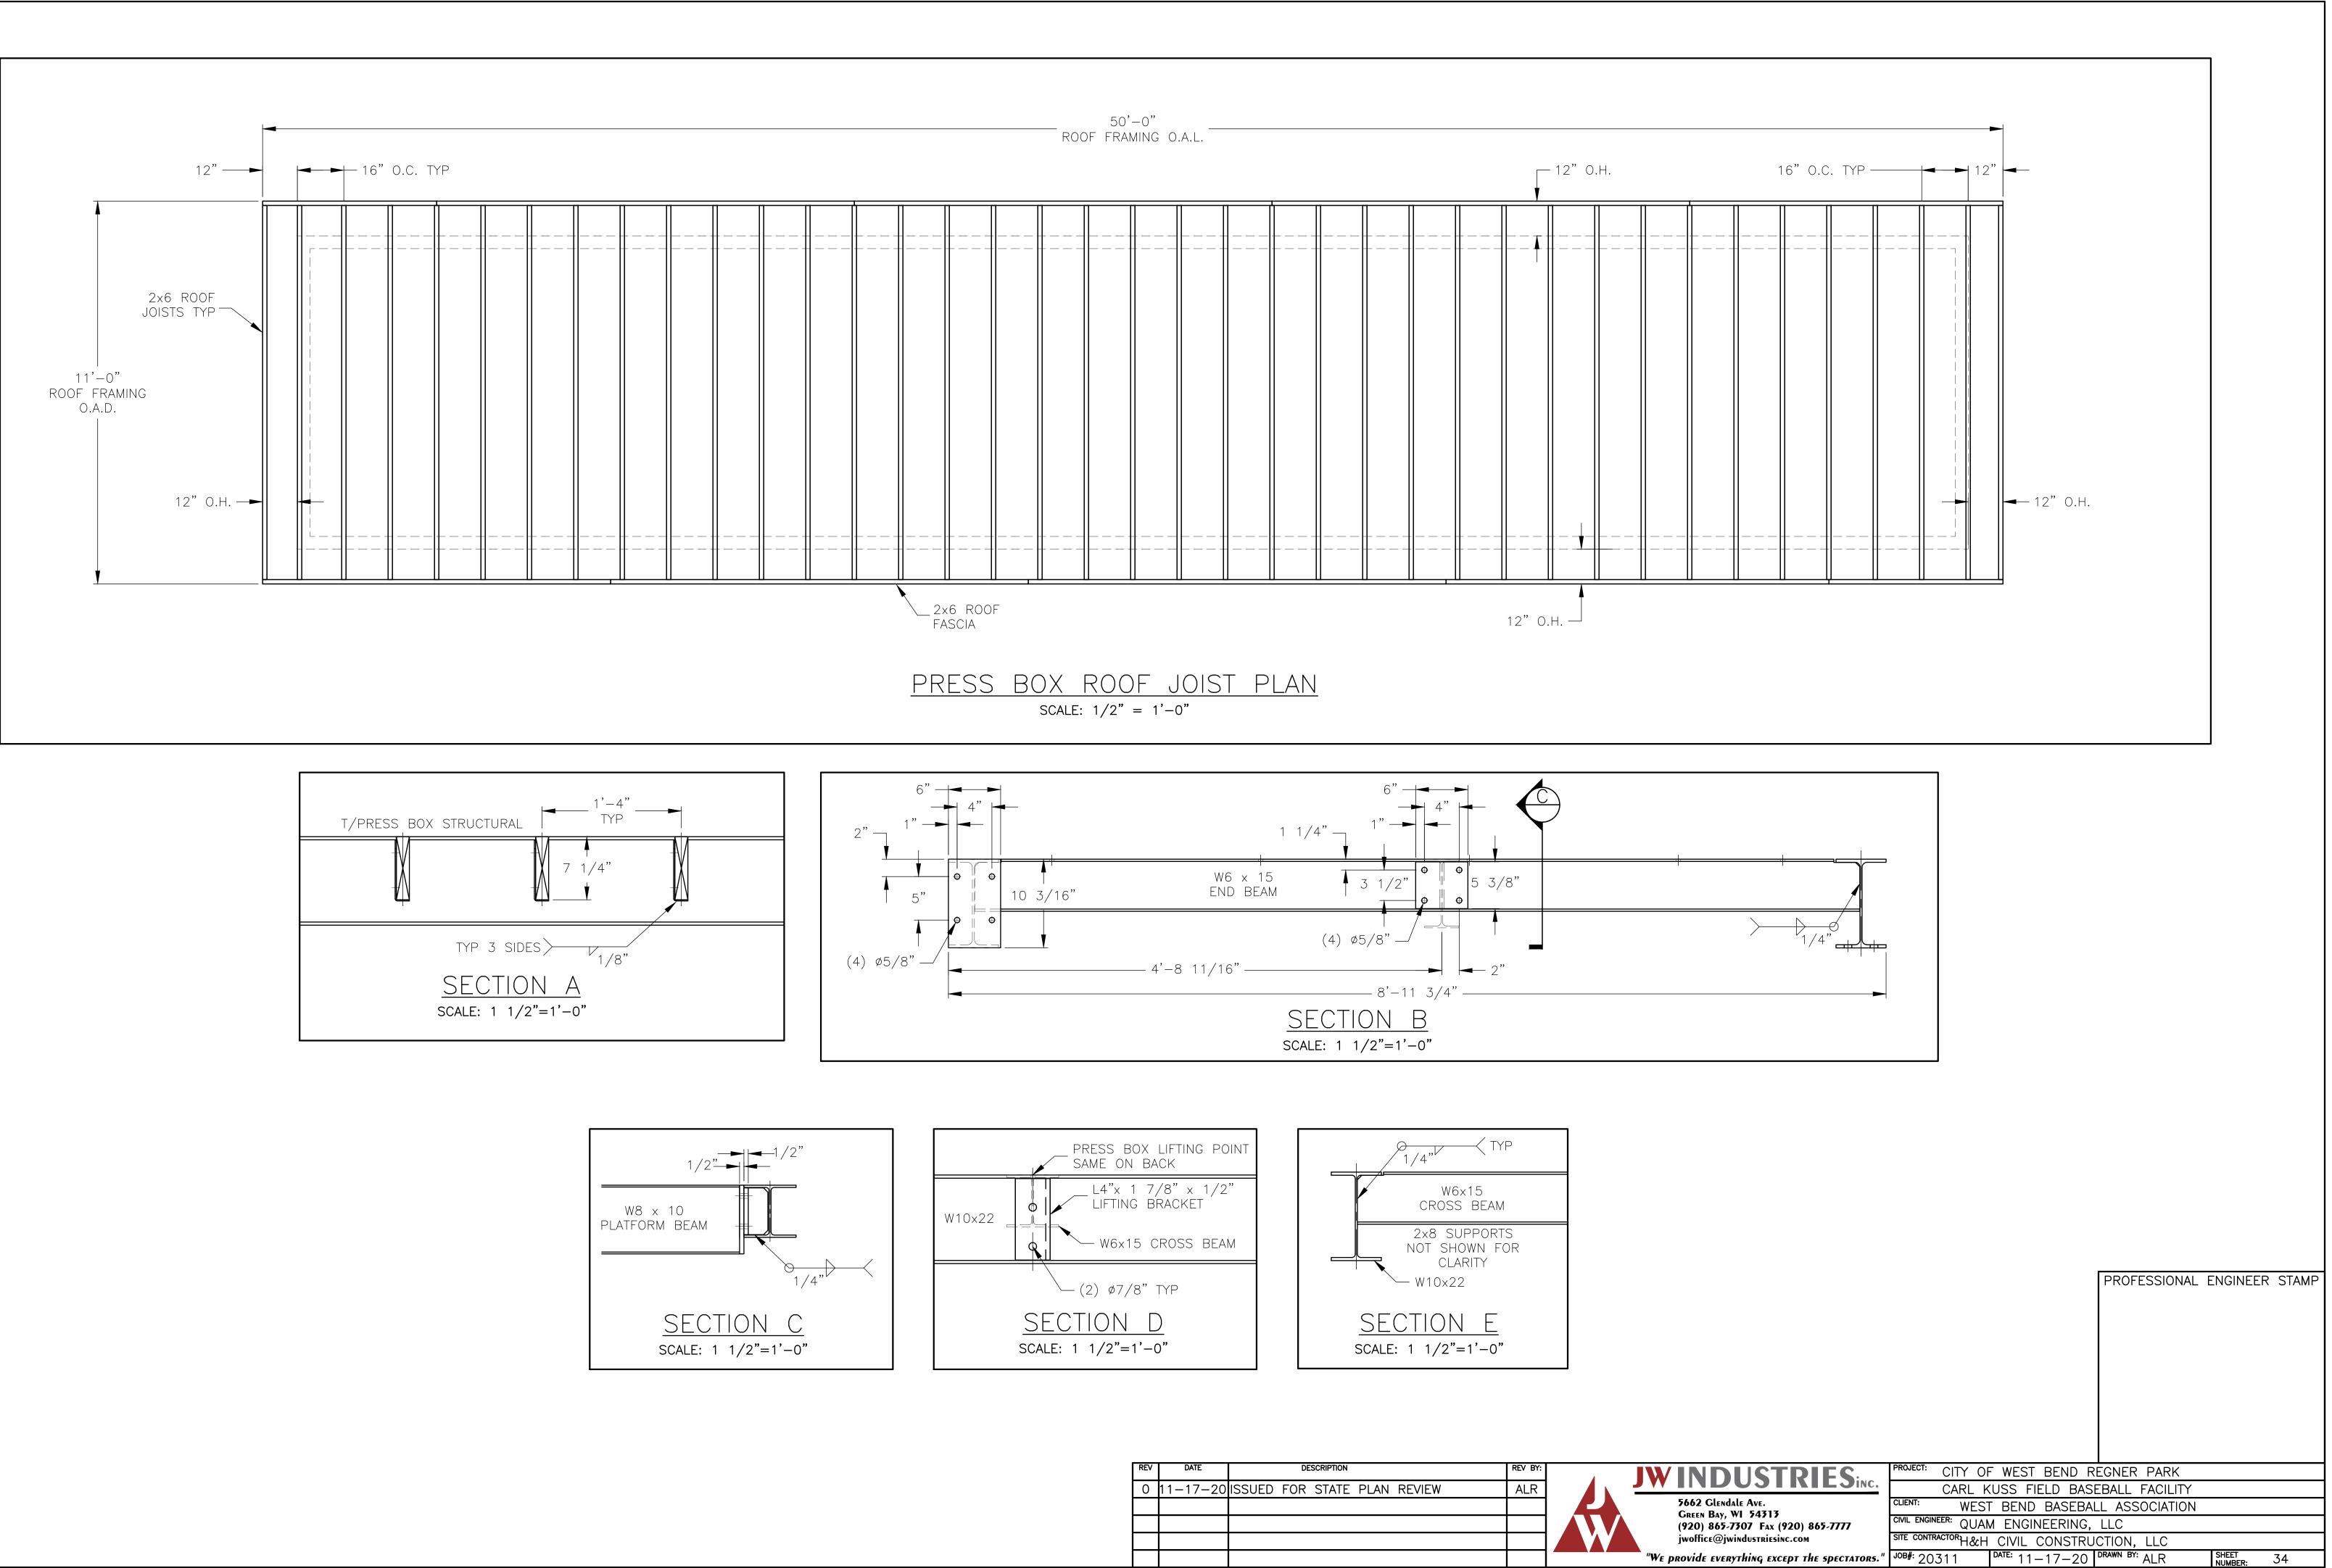

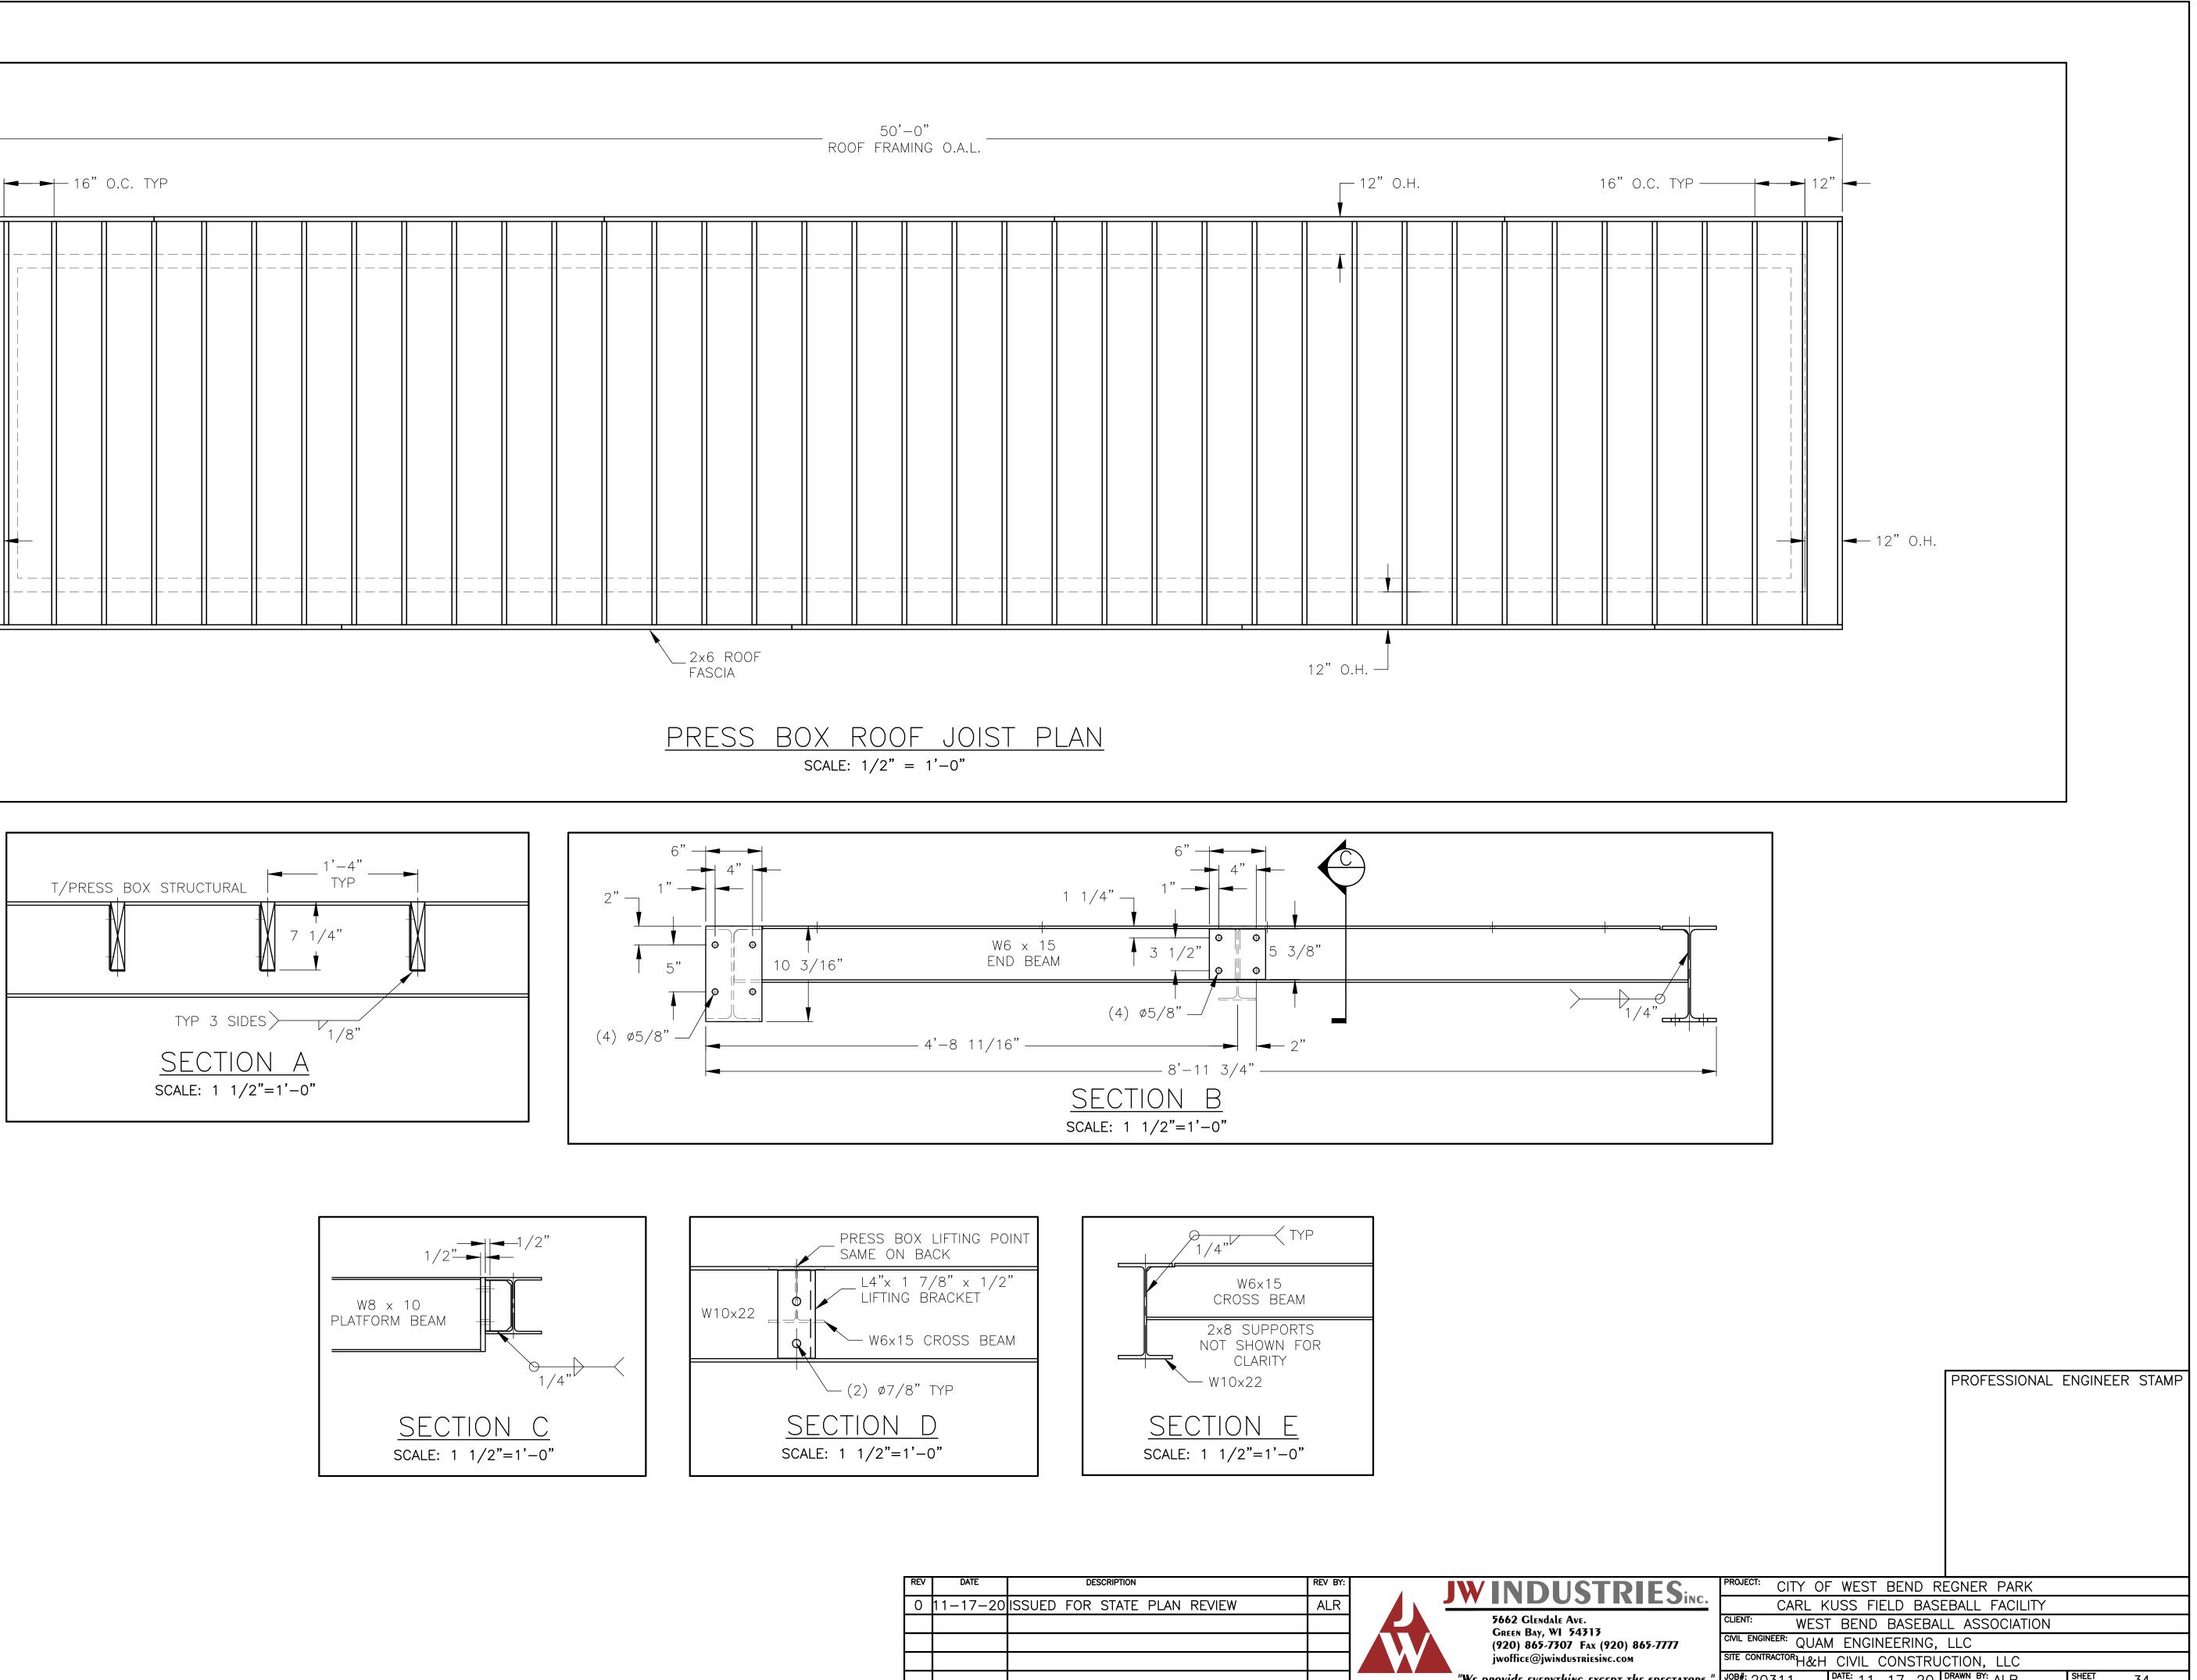

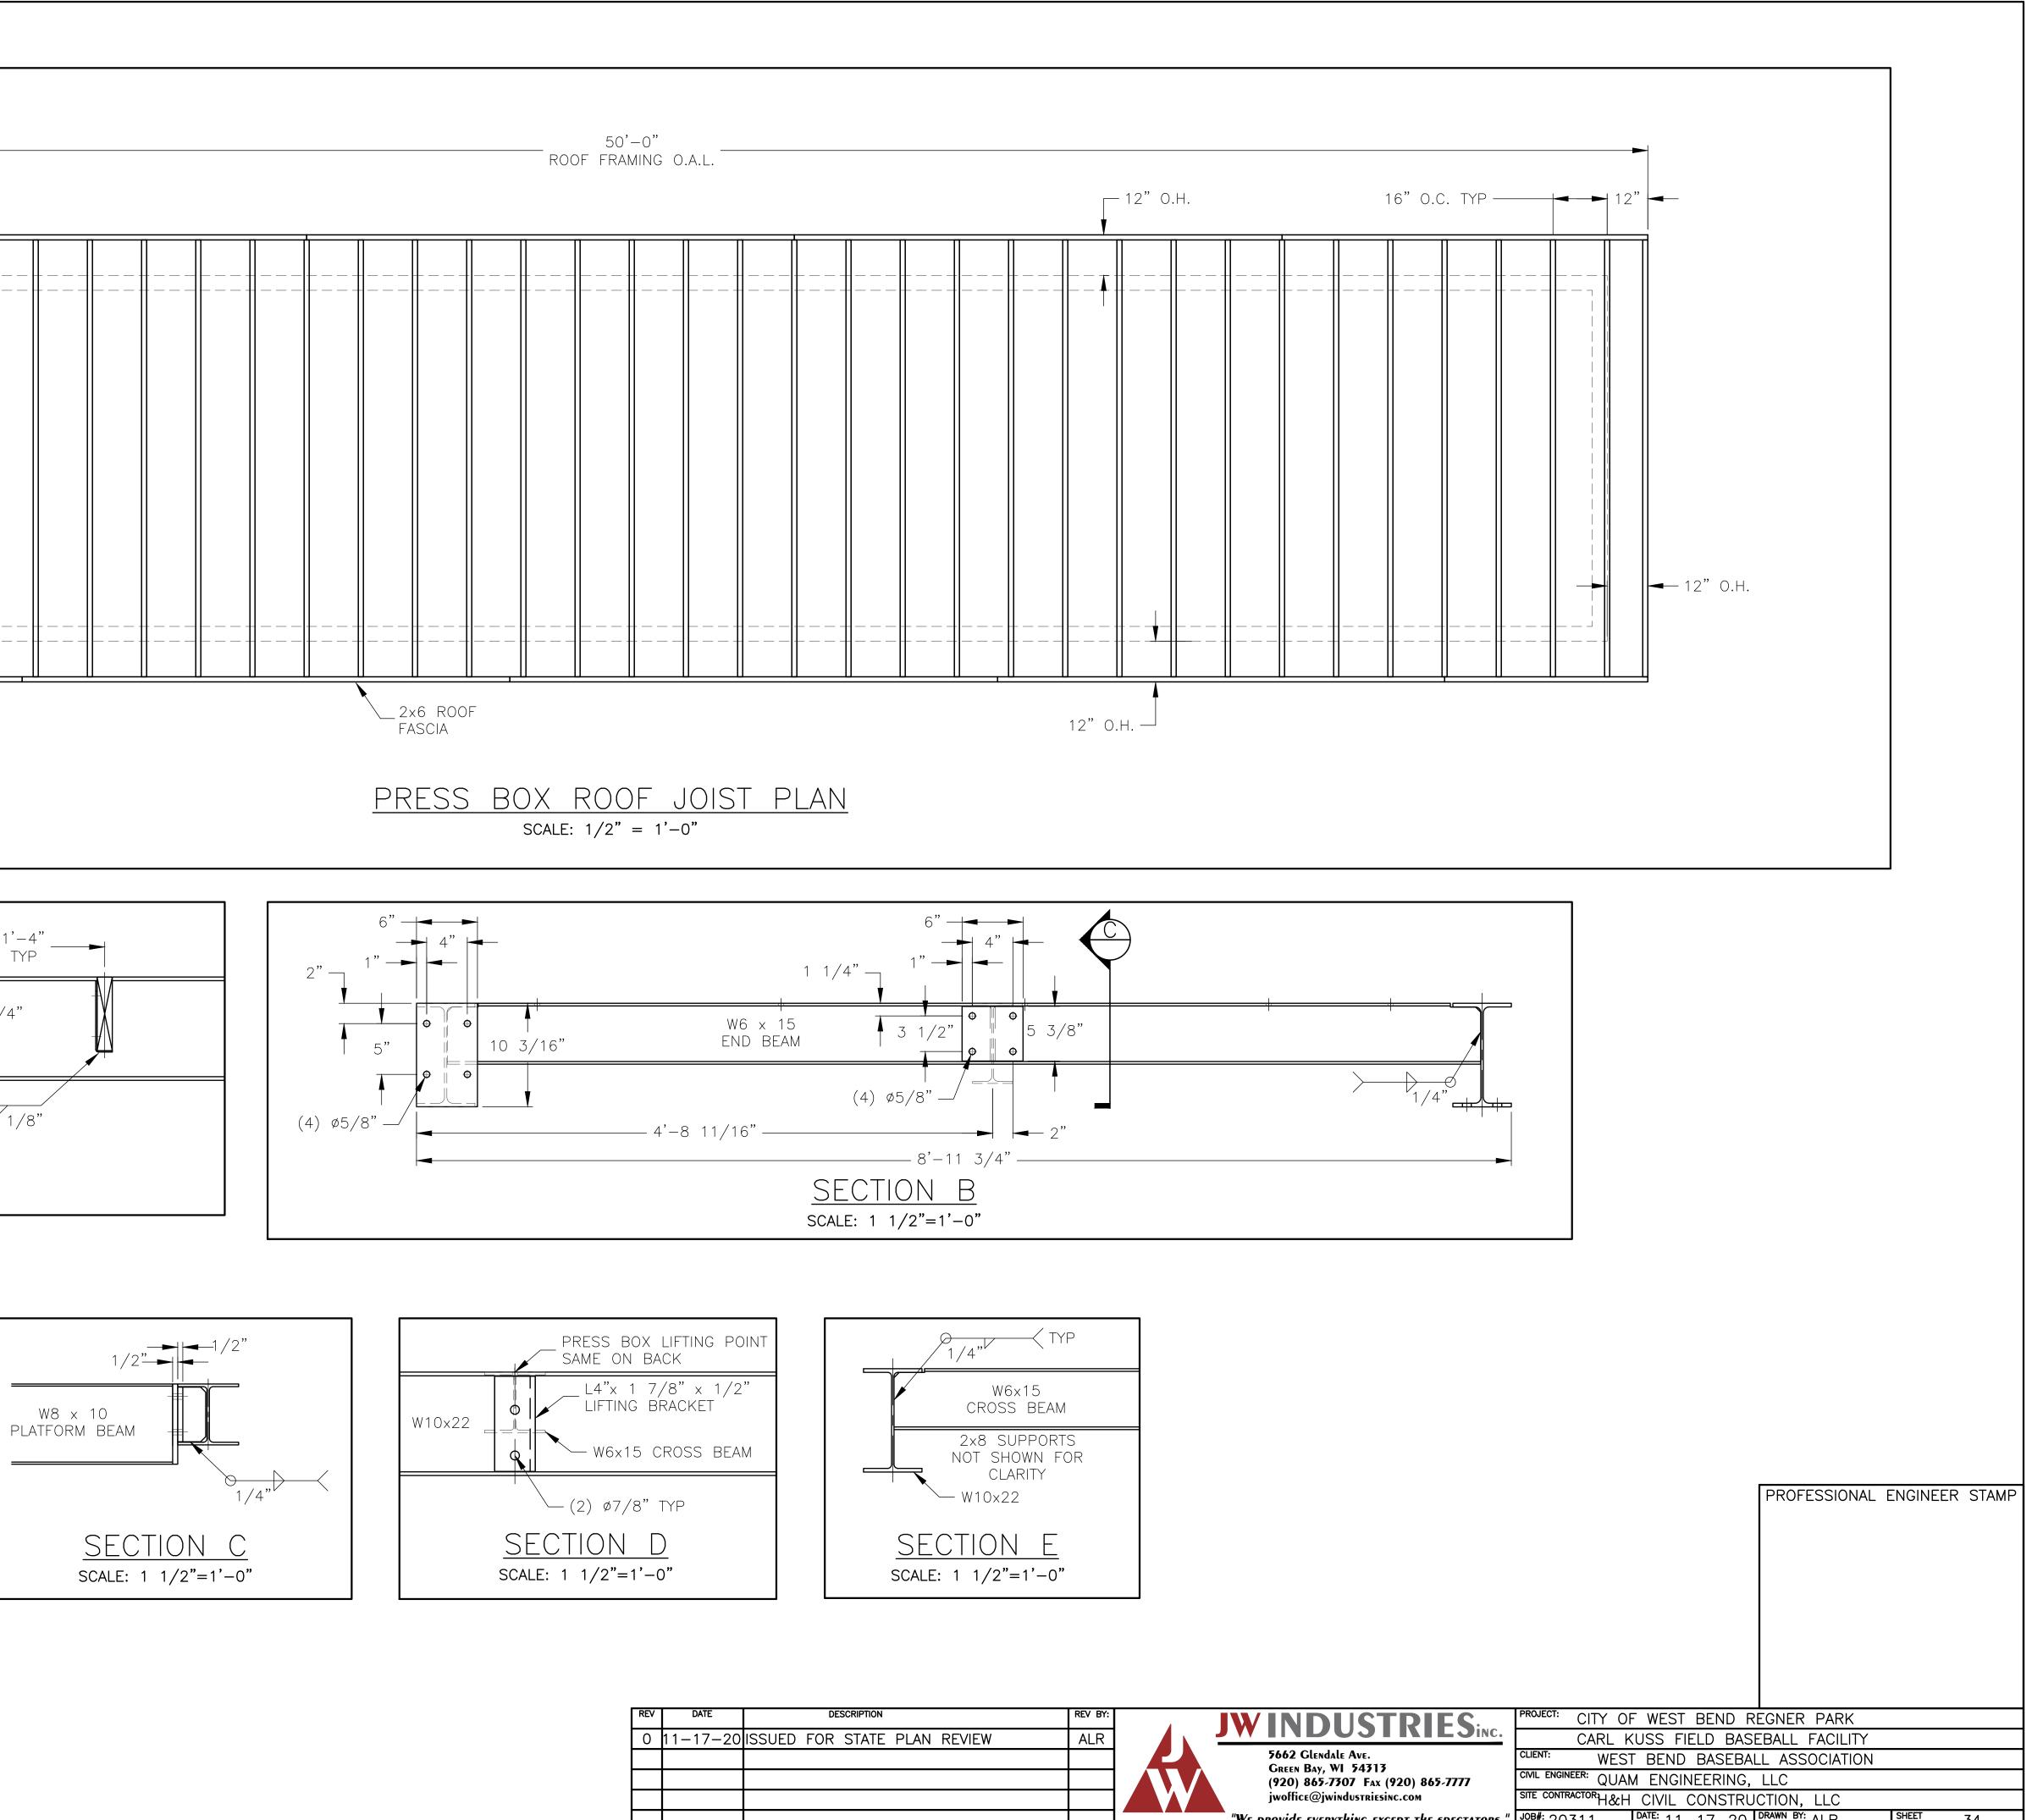

	REV BY:		DESCRIPTION	DATE	REV
	ALR	PLAN REVIEW	ISSUED FOR STATE	11-17-20	0
- F					

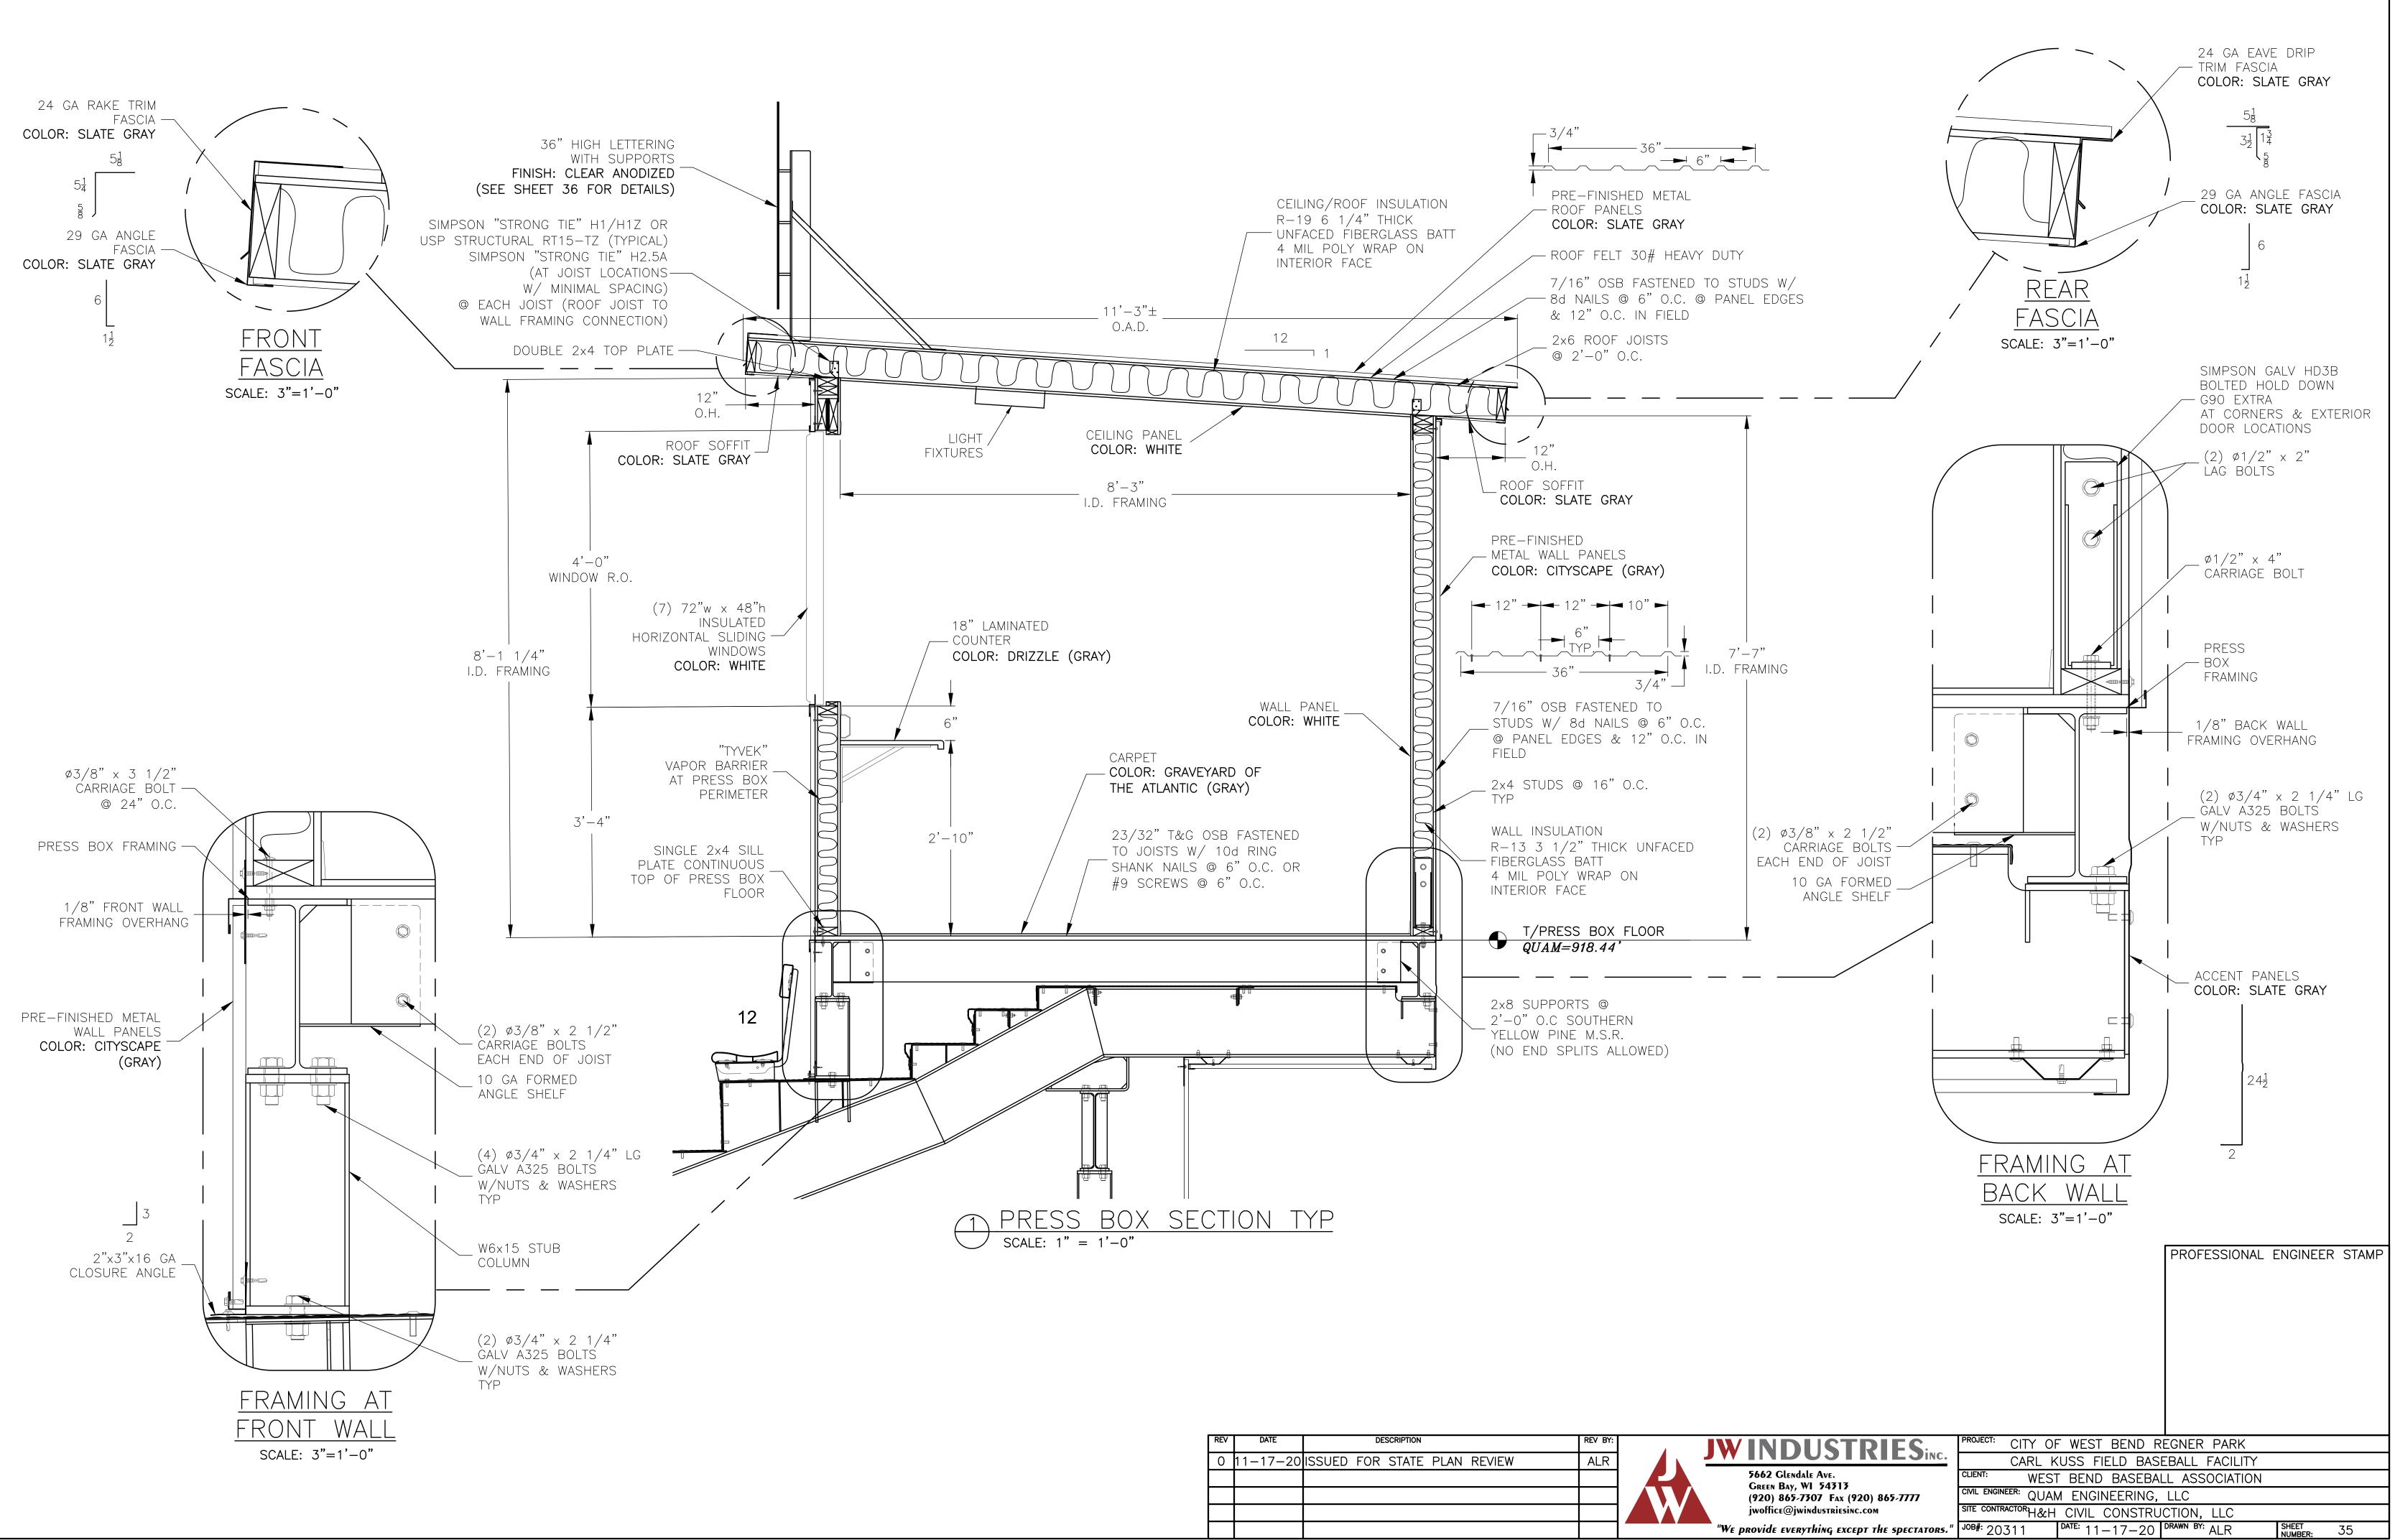

	REV	DATE	DESCRIPTION	REV BY:	
L					
	$\cap$	11 - 17 - 20	ISSUED FOR STATE PLAN REVIEW	ALR	
ļ	0	11-17-20	ISSUED FOR STATE FLAN REVIEW		
Ļ					
ļ					
ļ					

